

APPLICANT INFORMATION

Application for Architectural Review Board

* This application must be filled out completely and signed before submittals are placed on the ARB agenda.

The purpose of Architectural Review Board shall be to two-fold; to develop architectural and design guidelines for the City of Ladue in accordance with section 110-70 and to apply those guidelines in reviewing projects within the City as to whether or not the project adheres to such guidelines.

Name of Applicant:_	James	s Whalen	Project Manager, Whalen Custom Homes, Inc.			
Phone #:(314	4) 7 <u>12</u> -	4766				
Email address of App	licant (fo	r review comm	nents): james@whalencustomhomes.com			
PROJECT PROPERTY INFORMATION						
Address for proposed work: 9029 Clayton Rd. Ladue, MO 63117						
Zoning District:	С		Parcel ID # (St. Louis county record): 19K130202			

DESCRIPTION OF PROPOSED PROJECT: Construction of new single-family residence.


Additional Information:

- Professionally sealed plans are not required for ARB review.
- Plans for projects involving alterations and repairs, which do not affect the outward appearance of a building, and existing decks, fences, window replacements and roofing shingle replacements shall not require approval of the Architectural Review Board.
- Revised plans with any changes predicated by the ARB will need to be submitted with the building permit application to the Department of Planning and Development with final trustee approval (if applicable.)
- Projects approved by ARB should be submitted for building permits within 180 days or the ARB approval may become void.

By signing this application, you acknowledge that by submitting an incomplete application, your petition will not be added to the meeting agenda.

x The	Date: 7/30/2020
* = 1: 1: 1: 1: 1: 1: 1: 1: 1: 1: 1: 1: 1:	

* This application and review for City of Ladue building permitted purposes only. Please be aware of any additional covenants and indentures which may be recorded with your subdivision.

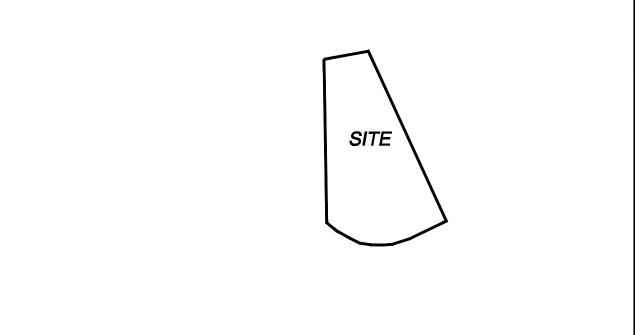

LOCATION MAP N.T.S.

DEVELOPMENT NOTES

LOCATOR NUMBER: 19K130202

1. SITE ADDRESS: 9029 CLAYTON ROAD LADUE, MO 63124

OWNER: WHALEN CUSTOM HOMES 338 S. KIRKWOOD RD.

2. EXISTING USE: SINGLE FAMILY RESIDENTIAL

3. PROPOSED USE: SINGLE FAMILY RESIDENTIAL
4. TOTAL SQUARE FOOTAGE OF LOT = 30,051 SF (0.69 ACRES±)

KIRKWOOD, MO 63122

GENERAL NOTES:

- 1. UNDERGROUND FACILITIES, STRUCTURES AND UTILITIES HAVE BEEN PLOTTED FROM AVAILABLE SURVEYS AND RECORDS AND THEREFORE THEIR LOCATIONS MUST BE CONSIDERED APPROXIMATE ONLY. IT IS POSSIBLE THAT THERE MAY BE OTHER, THE EXISTENCE OF WHICH IS PRESENTLY NOT KNOWN OR SHOWN. IT IS THE CONTRACTOR'S RESPONSIBILITY TO DETERMINE THEIR EXISTANCE AND EXACT LOCATION BEFORE EXCAVATION OR TRENCHING TO AVOID DAMAGE THERETO.
- 2. THE CONTRACTOR SHALL BE RESPONSIBLE FOR COORDINATING ALL NECESSARY INSPECTIONS WITH ALL GOVERNING AGENCIES AND UTILITY COMPANIES INVOLVED WITH THIS PROJECT. THE CONTRACTOR SHALL ALSO PAY ANY FEES ASSOCIATED WITH PERMITS, INSPECTOINS AND ANY OTHER CONSTRUCTION RELATED ACTIVITIES.
- 3. THE STREETS SURROUNDING THIS DEVELOPMENT AND ANY STREET USED FOR CONSTRUCTION ACCESS THERETO SHALL BE KEPT FREE FROM MUD AND CONSTRUCTION DEBRIS AND SHALL BE CLEANED THROUGHOUT THE DAY AS
- 4. ALL FILLS PLACED UNDER PROPOSED STORM AND SANITARY LINES AND/OR PAVED AREAS SHALL BE COMPACTED TO 90% OF MAXIMUM DENSITY AS DETERMINED BY THE "MODIFIED AASHTO T-180 COMPACTION TEST" (ASTM D-1557) FOR THE ENTIRE DEPTH OF THE FILL. COMPACTED GRANULAR BACKFILL IS REQUIRED IN ALL TRENCH EXCAVATION AND UNDER PAVED AREAS. ALL TESTS SHALL BE PERFORMED UNDER THE DIRECTION OF AND VERIFIED BY SOILS ENGINEER CONCURRENT WITH GRADING AND BACKFILLING OPERATIONS.
- 5. ALL SEWER CONSTRUCTION AND CONNECTIONS SHALL BE AS APPROVED BY THE METROPOLITAN ST. LOUIS SEWER DISTRICT AND IN ACCORDANCE WITH THE STANDARD CONSTRUCTION SPECIFICATIONS FOR SEWERS AND DRAINAGE
- 6. SANITARY SEWER SERVICE: NEW SANITARY SEWER LATERAL SHALL BE 6" PVC AT 2% MINIMUM SLOPE. FOLLOW ALL MSD STANDARDS FOR MACHINE TAP AND ROLL—IN WYE TRENCHING AND BACKFILL. CONTRACTOR SHALL MAINTAIN A MINIMUM OF 3 FEET OF COVER OVER THE PROPOSED SEWER LATERAL.
- 7. WATER SERVICE: NEW WATER SERVICE SHALL BE 1" WITH STANDARD RESIDENTIAL METER ACCORDING TO MISSOURI AMERICAN WATER COMPANY STANDARDS. THE CONTRACTOR SHALL COORDINATE WITH MISSOURI AMERICAN WATER COMPANY TO DETERMINE THE SIZE OF EXCAVATION NECESSARY FOR INSTALLATION OF THE 1" WATER SERVICE LINE, VALVE, AND TAP. THE CONTRACTOR IS RESPONSIBLE FOR ALL EXCAVATION, BACKFILL, AND THE SUPPLY AND INSTALLATION OF THE VALVE BOXES AND APPROPRIATE FRAME AND COVERS FOR THE 1" SERVICE LINE VALVE.
- 8. GAS SERVICE: NEW GAS SERVICE SHALL BE DETERMINED BY SPIRE GAS COMPANY. SPIRE GAS COMPANY SHALL DESIGN AND CONSTRUCT NEW GAS METER AND NEW GAS PIPING FROM THE BUILDING IN APPROXIMATE LOCATION SHOWN TO THE EXISTING GAS MAIN. CONTRACTOR SHALL COORDINATE WITH SPIRE GAS TO SCHEDULE NEW CONSTRUCTION WORK.
- 9. ALL TRASH AND DEBRIS ON-SITE, EITHER EXISTING OR FROM CONSTRUCTION, MUST BE REMOVED AND PROPERLY DISPOSED OF OFF-SITE.
- 10. DEBRIS AND FOUNDATION MATERIAL FROM ANY EXISTING ON—SITE BUILDING OR STRUCTURE WHICH IS SCHEDULED TO BE RAZED FOR THIS DEVELOPMENT MUST BE PROPERLY DISPOSED OF OFF—SITE.
- 11. ANY WELLS, CISTERNS, AND/OR SPRINGS, WHICH MAY EXIST ON THIS PROPERTY, SHOULD BE LOCATED AND SEALED IN A MANNER ACCEPTABLE TO THE CITY OF LADUE AND THE MODNR.
- 12. ALL EXISTING UTILITY CONNECTIONS ARE TO BE VERIFIED BY THE CONTRACTOR PRIOR TO CONSTRUCTION. CONTRACTOR SHALL NOTIFY THE DEVELOPER OF ANY
- CONFLICTS OR ISSUES PRIOR TO CONSTRUCTION.


 13. DEMOLITION OF EXISTING STRUCTURES ARE NOT PART OF THIS CONTRACT.
- 14. RETAINING WALL DESIGN BY OTHERS.
- 15. THE PROPOSED STORMWATER STORAGE BED BMP'S ARE UNDER THE CITY OF LADUE JURISDICTION.
- 16. SWIMMING POOL BACKWASH FILTER MUST BE CONNECTED TO THE SANITARY
- SEWER. DISCHARGE MUST NOT EXCEED FIFTY (50) GALLONS PER MINUTE.


 17. BACKWATER VALVE SHALL BE REQUIRED ON ALL BUILDING LATERALS PER LOCAL
- PLUMBING CODE.

 18. MANUAL DRAINAGE OF POOL SHALL BE DIRECTED TO SANITARY CLEANOUT.


GRADING NOTES:

- 1. ALL GRADING AND DRAINAGE SHALL BE PER CITY OF LADUE AND METROPOLITAN ST. LOUIS SEWER DISTRICT STANDARDS.
- 2. STORM WATER PIPES CANNOT DISCHARGE ANY CLOSER THAN 10 FEET TO A PROPERTY LINE.
- 3. THE CITY OF LADUE GRADING INSPECTOR SHALL BE ALLOWED TO REQUEST MINOR CHANGES TO THE FINISH GRADE AND/OR STOR WATER RUNOFF DESIGN.
- 4. NO SLOPES SHALL EXCEED 3 (HORIZONTAL) TO 1 (VERTICAL), UNLESS JUSTIFIED BY GEOTECHNICAL REPORT WHICH HAS BEEN ACCEPTED/APPROVED BY THE CITY OF LADUE. NO SLOPES WITHIN MODOT RIGHT-OF-WAY SHALL EXCEED 3 (HORIZONTAL) TO 1 (VERTICAL).
- 5. ALL DISTURBED AREAS ARE TO BE SEEDED AND STRAWED.
- 6. SILTATION CONTROL FENCING SHALL BE INSTALLED AT THE LOW SIDE OF THE JOB SITE TO PREVENT SOIL EROSION ONTO ADJACENT PROPERTIES.

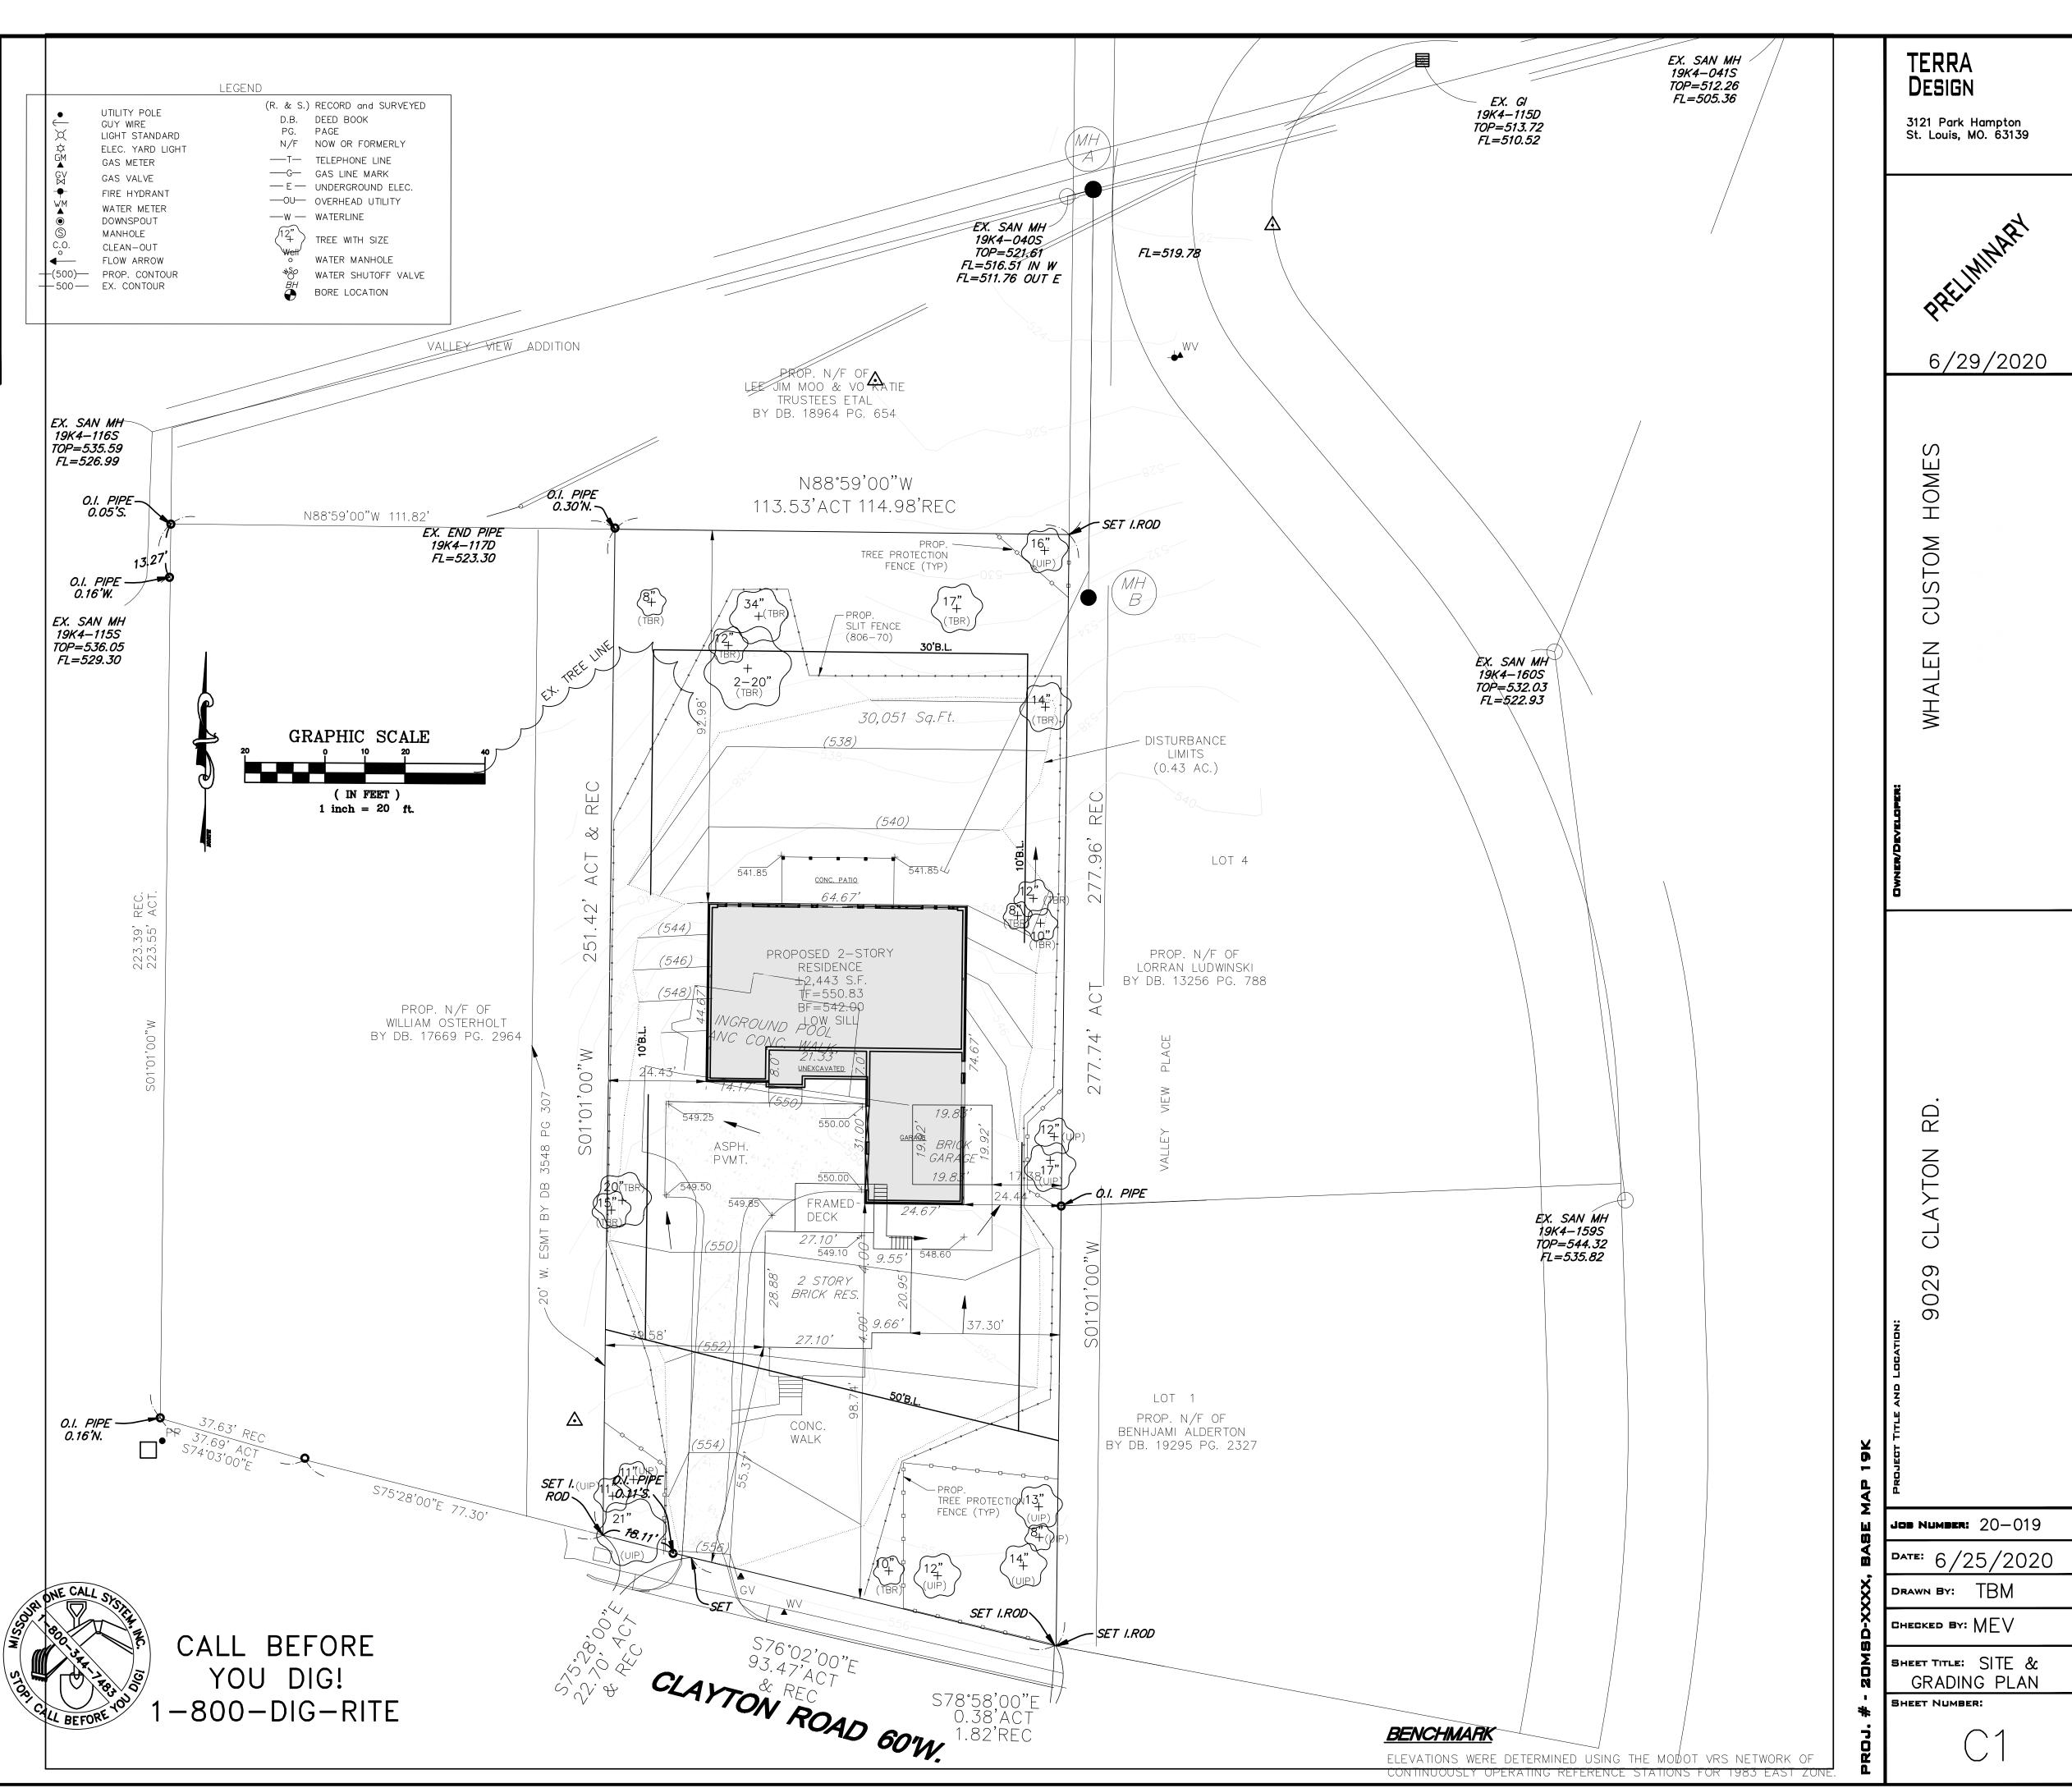


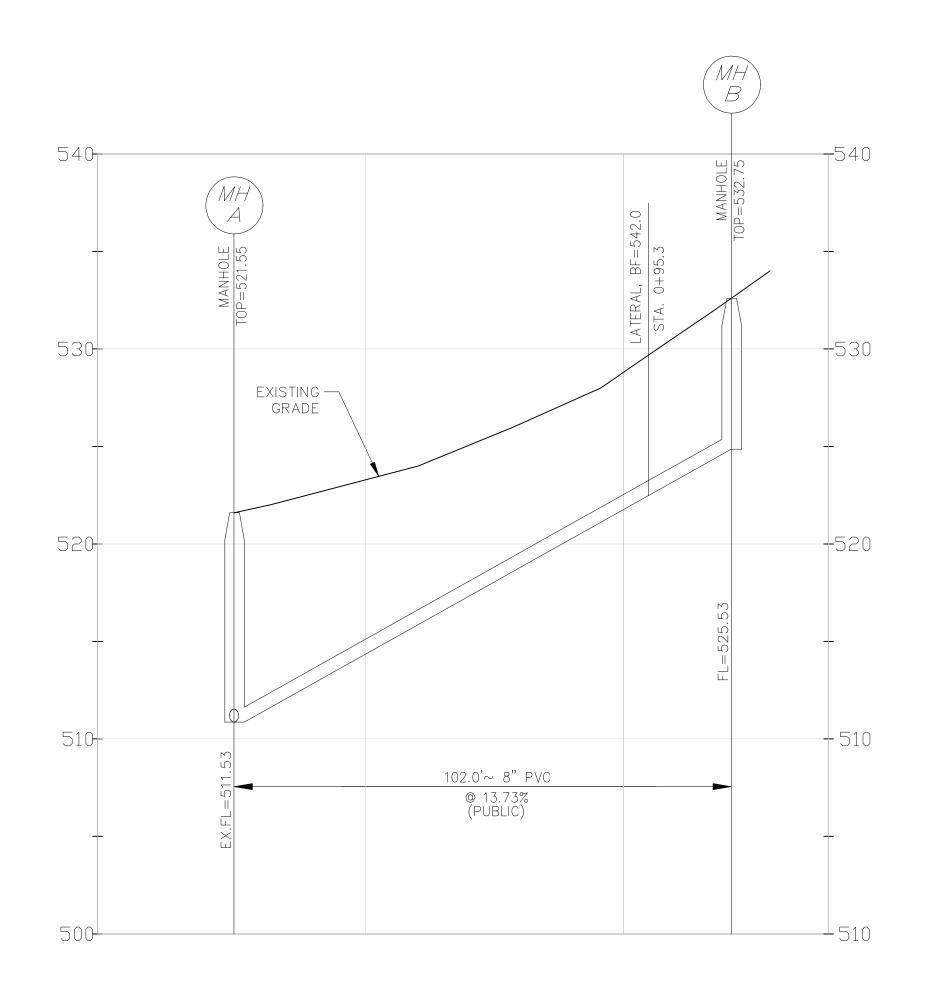

SANITARY PROFILE

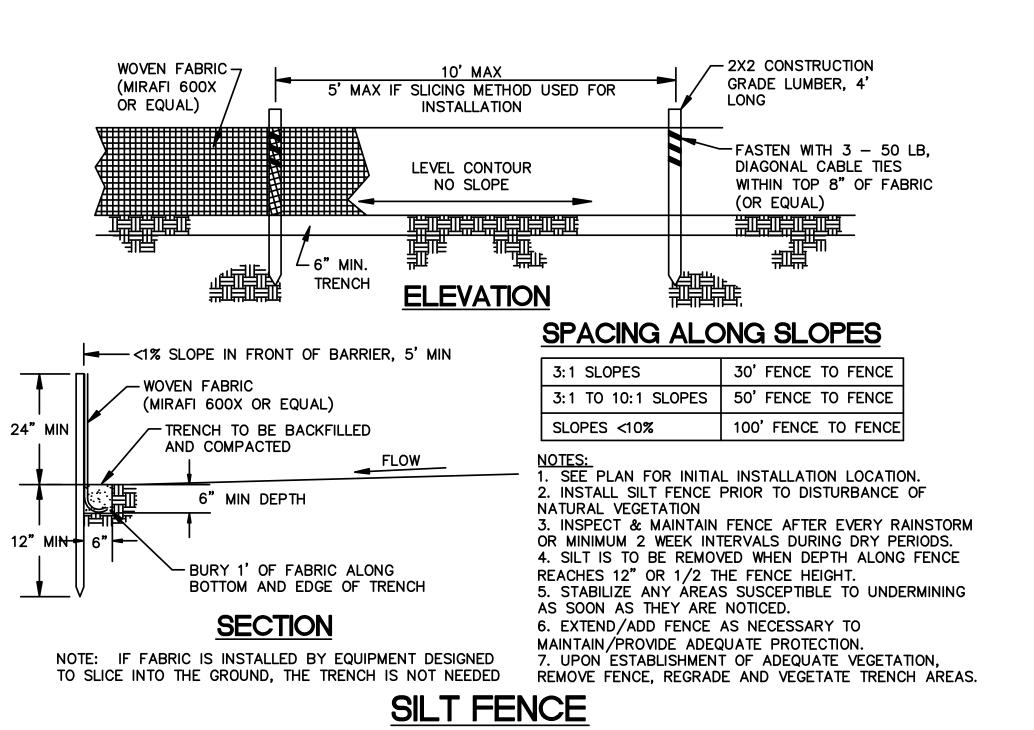


N.T.S.

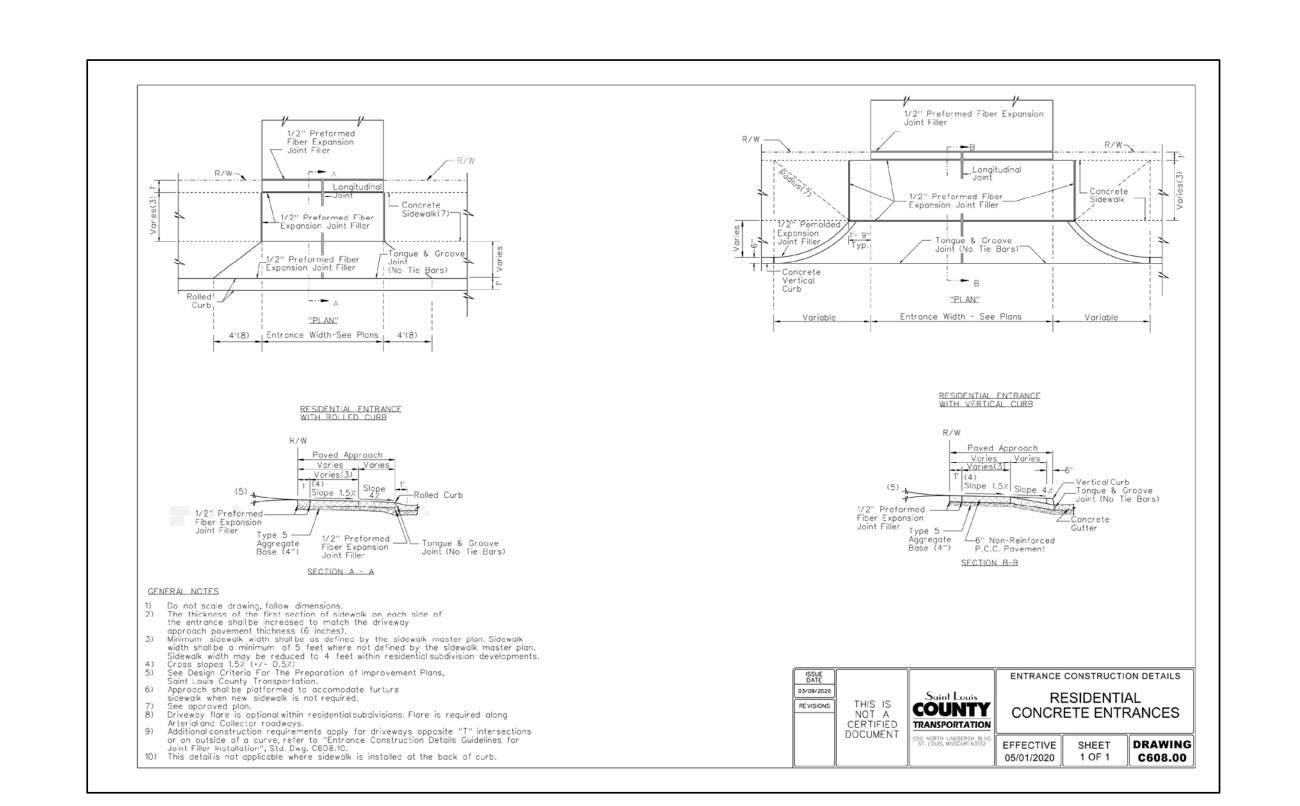


TERRA DESIGN 3121 Park Hampton St. Louis, MO. 63139 6/29/2020 HOME TOM S \mathbb{C} WHALEN 902 JOB NUMBER: 20-019 DATE: 6/25/2020

DRAWN BY: TBM CHECKED BY: MEV

SHEET TITLE: PROFILE & DETAILS SHEET NUMBER:

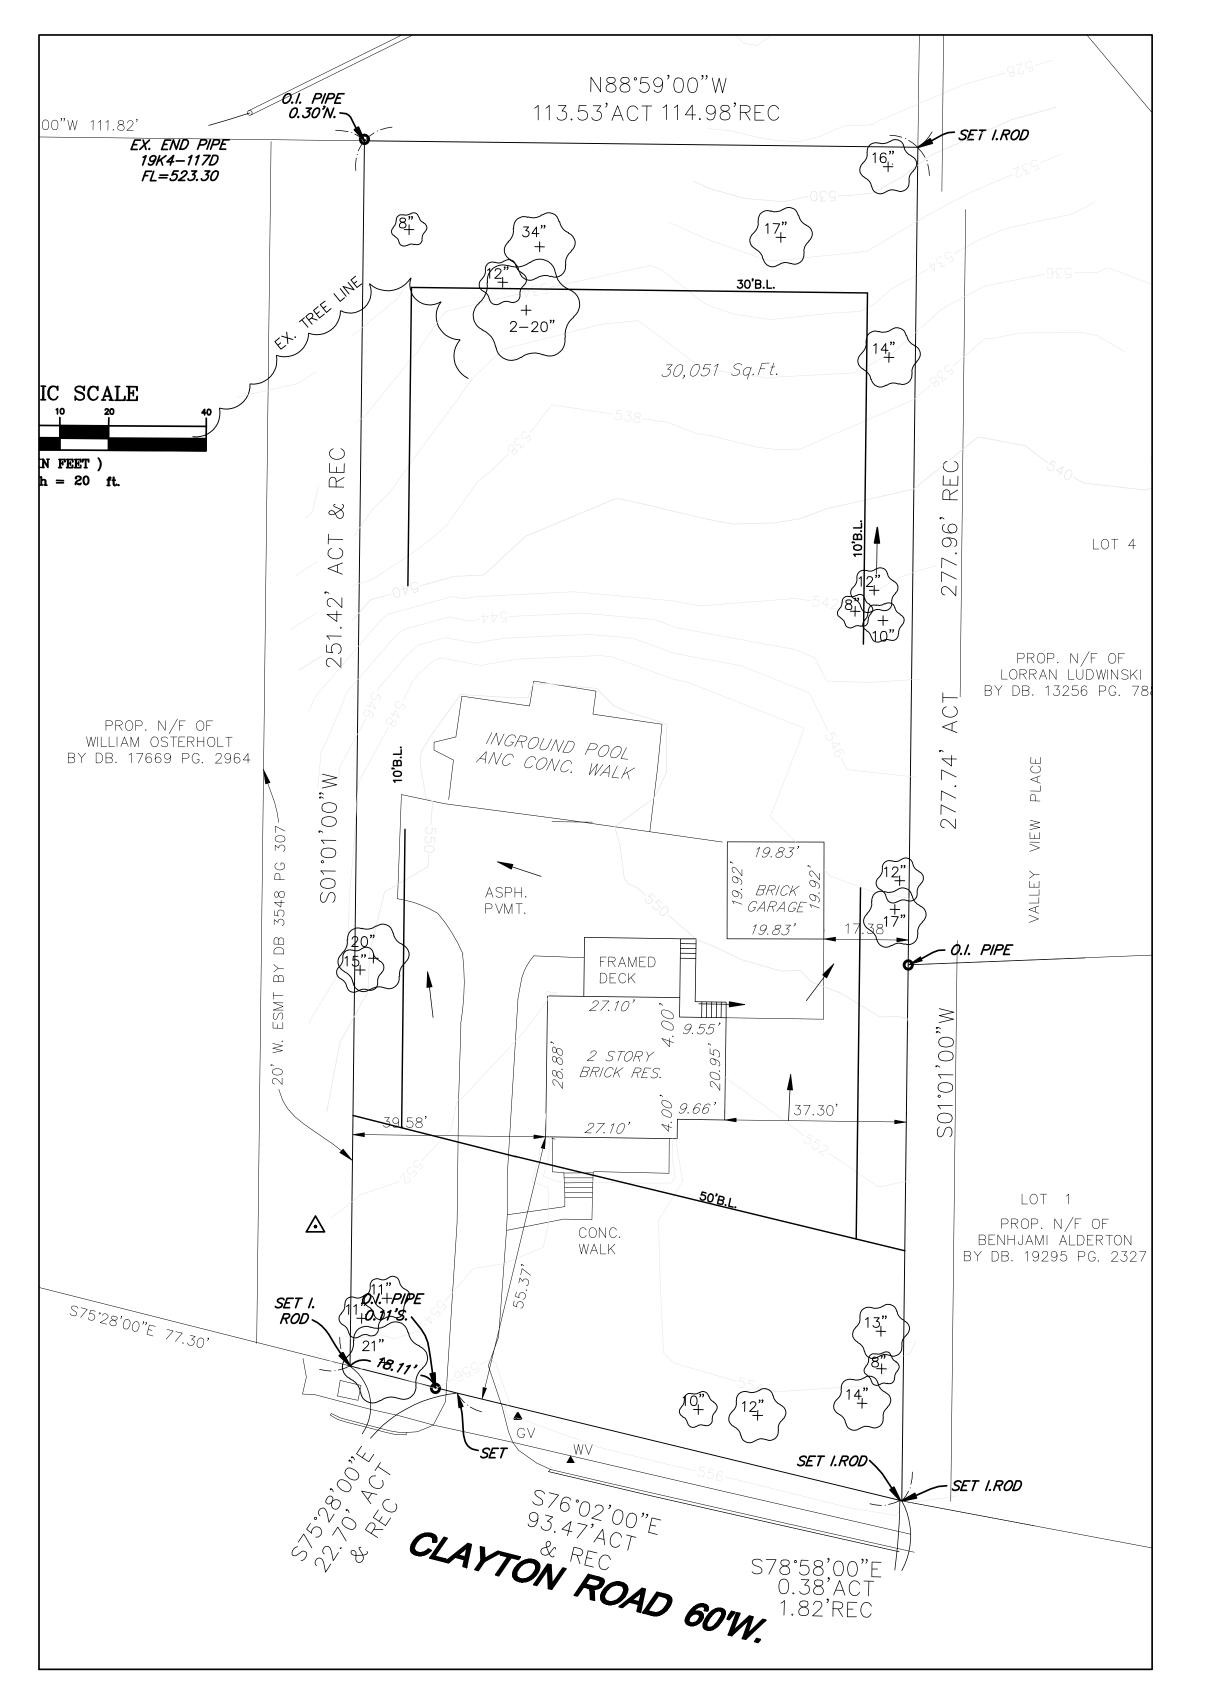

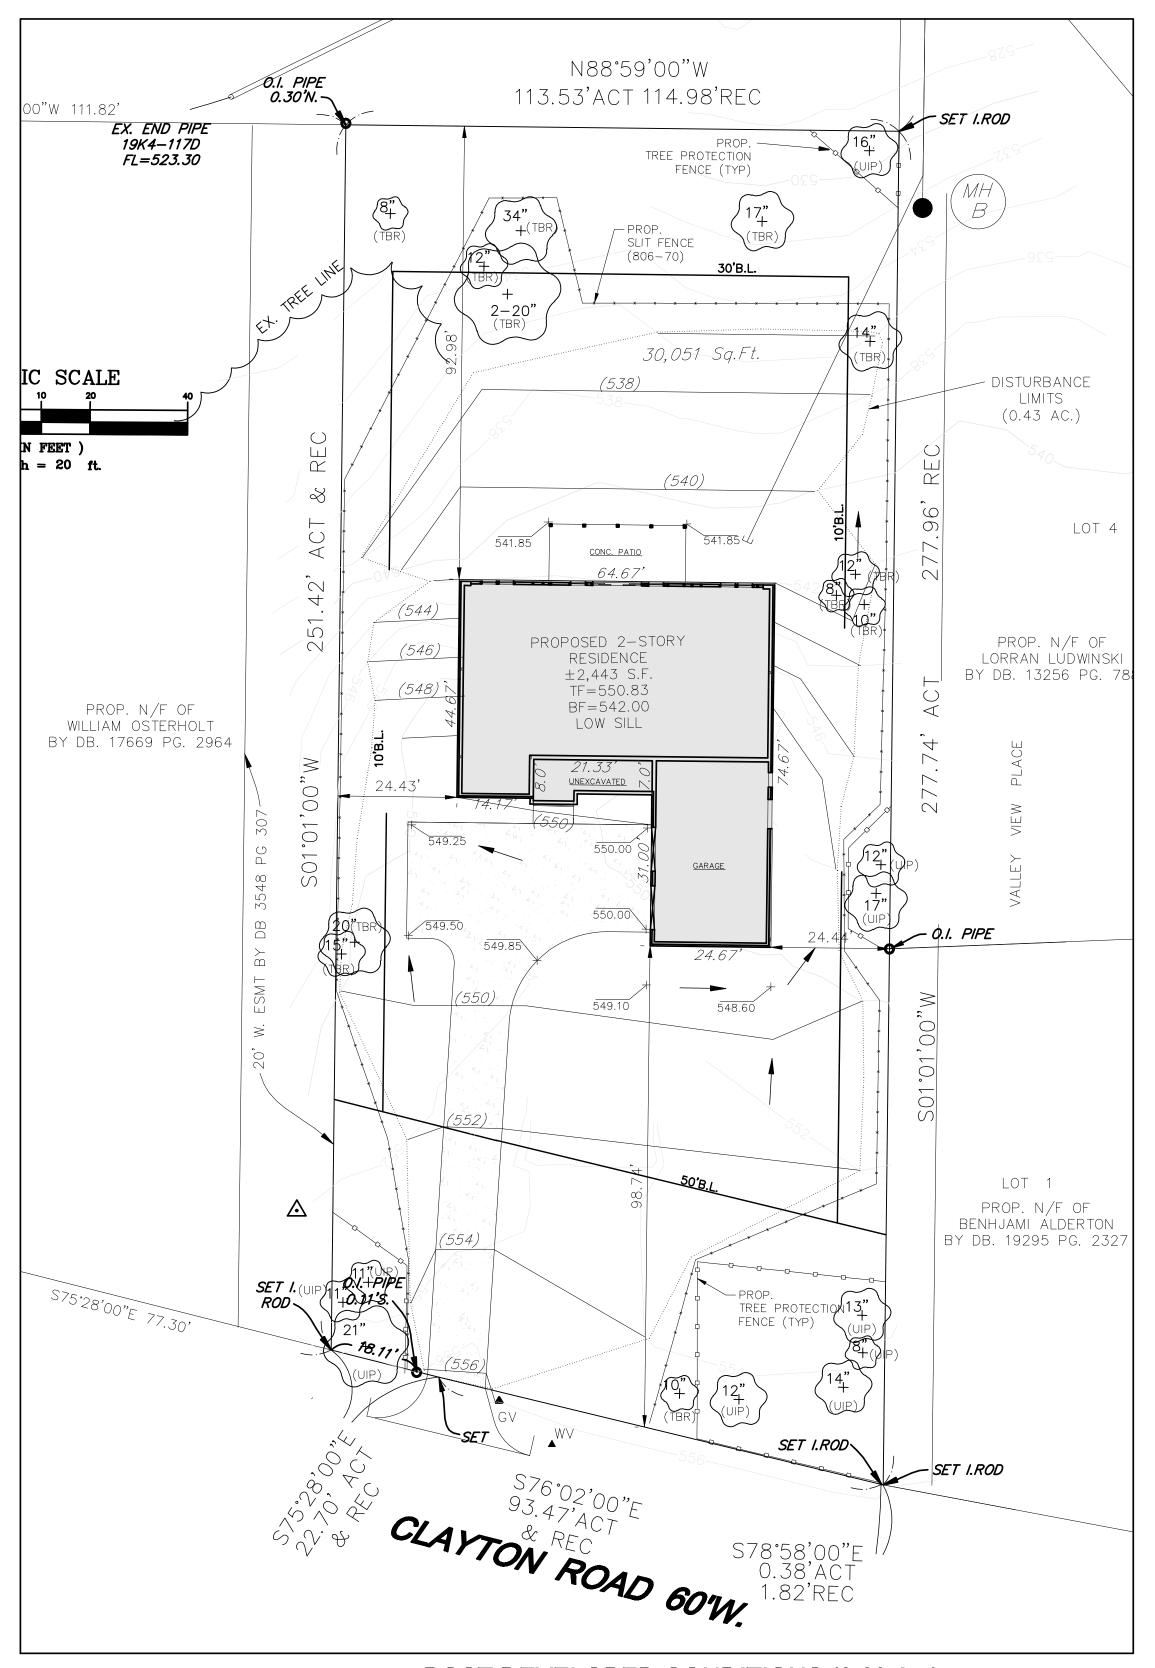

PRE DEVELOPED CONDITIONS (0.69 AC)

PERVIOUS AREA = 0.55 AC. x PI=1.70 (15 YR) TOTAL PERVIOUS AREA CFS = 0.94 CFS

IMPERVIOUS AREA = 0.14 AC. x PI=3.54 (15 YR) TOTAL IMPERVIOUS AREA CFS = 0.50 CFS

TOTAL= 1.44 CFS

DIFFERENTIAL RUNOFF CALCULATIONS (15 YR)
PRE DEVELOPED CONDITIONS
1.44 CFS
POST DEVELOPED CONDITIONS
1.39 CFS
DIFFERENTIAL RUNOFF RATE -0.05 CFS

POST DEVELOPED CONDITIONS (0.69 Ac.)

PERVIOUS AREA = 0.57 AC.

x PI=1.70 (15 YR)

TOTAL PERVIOUS AREA CFS = 0.97 CFS

IMPERVIOUS AREA = 0.12 AC.

x PI=3.54 (15 YR)

TOTAL IMPERVIOUS AREA CFS = 0.42 CFS

TOTAL=1.39 CFS

STORMWATER MANAGEMENT NOTE:

LAND AREA DISTURBED = 0.43 ACRES

ANY FUTURE LAND DISTURNBANCE AND/OR INCREASE IN IMPERVIOUS AREA ON THIS SITE REQUIRES ADDITIONAL STORM WATER MANAGEMENT PER REGULATIONS IN PLACE AT THAT TIME.

TERRA DESIGN

3121 Park Hampton St. Louis, MO. 63139

6/25/2020

WHALEN CUSTOM HOMES 338 S. Kirkwood Road Kirkwood, MO 63122 314-821-1745

9029 CLAYTON ROAD Ladue, MO 63124

JOB NUMBER: 20-019

6/25/2020

DRAWN BY: TBM

CHECKED BY: MEV

SHEET NUMBER:

SHEET TITLE: DRAINAGE AREA MAPS

C4

PROJECT CONSULTANTS

ARCHITECT THOMAS ALAN GROUP 23 NORTH GORE AVENUE

SUITE 303 WEBSTER GROVES, MO 63119

(314) 301-9975 (314) 913-4106 CHRIS PIKE: CPIKE@TAG-STL.COM AJ CALTETT: (314) 920-7801

EMAIL: JCATLETT@TAG-STL.COM

STRUCTURAL CONSULTANT

DREAM RUNNERS, LTD. 43 CAMROSE GREEN MARYVILLE, ILLINOIS 62062 PHONE: (618) 550-9417 (618) 288-3782

WWW.DREAMRUNNERS-LTD.COM

GENERAL CONTRACTOR

WHALEN CUSTOM HOMES 338 S. KIRKWOOD RD. SUITE 103 KIRKWOOD, MO 63122

PHONE: (314) 575-7645

WWW.WHALENCUSTOMHOMES.COM

PROJECT INFORMATION

APPLICABLE BUILDING CODES: INTERNATIONAL RESIDENTIAL CODE (2015) INTERNATIONAL MECHANICAL CODE (2015) UNIFORM PLUMBING CODE (2015) NATIONAL ELECTRIC CODE (2014) LOCAL CITY AND ORDINANCES

CONSTRUCTION TYPE: TYPE VB (5B) UNPROTECTED, UNSPRINKLERED

OCCUPANCY: SINGLE FAMILY DWELLING

SHEET TITLE INDEX

COVER SHEET

GENERAL NOTES GENERAL NOTES A2 A3 FOUNDATION PLAN & STAIR SECTION FINISHED LOWER LEVEL **A4** FIRST FLOOR PLAN **A6** ATTIC PLAN AND ROOF PLAN FRONT ELEVATION & LEFT ELEVATION **A7 REAR ELEVATION & RIGHT ELEVATION A9** SECTIONS AND DETAILS A10 FINISHED LOWER LEVEL ELECTRICAL A11

FIRST FLOOR PLAN ELECTRICAL UNFINISHED ATTIC ELECTRICAL A12

S1 STRUCTURAL FOUNDATION PLAN S2 STRUCTURAL FIRST FLOOR PLAN STRUCTURAL ATTIC PLAN S3

S4 STRUCTURAL ROOF/FRAMING PLAN STRUCTURAL SECTIONS AND DETAILS

ABBREVIATIONS


ABV.	-ABOVE	DR.	-DOOR	IJS	-IN JOIST SPACE	SA	-SUPPLY AIR
A.F.F.	-ABOVE FINISHED FLOOR	D.S.	-DOWNSPOUT	INSUL.	-INSULATION	STRUCT.	-STRUCTURAL
AHU	-AIR HANDLING UNIT	DTL.	-DETAIL	I.B.	-IRONING BOARD	ST'L.	-STEEL
ALUM.	-ALUMINUM	DW	-DRYWALL	ITS	-IN TRUSS SPACE	S.D.	-SMOKE DETECTOR
ALT.	-ALTERNATE	DW. OPNG	-DRYWALL OPENING	JST.	-JOIST	S.F.	-SQUARE FEET
ASPH.	-ASPHALT	EA.	-EACH	K.S.	-KNEE SPACE	SG-I	-TYPE I SAFETY GLAZING
BM.	-BEAM	E.I.F.S.	-EXTERIOR INSULATION FINISH	L.V.L.	-LAMINATED VENEER LUMBER	SG-II	-TYPE II SAFETY GLAZING
BP.	-BEAM POCKET	SYSTEM		LIN.	-LINEN	SH.	-SHELF/SHELVES
BRG	-BEARING	EJ	-EXPANSION JOINT	LNDRY	-LAUNDRY	SHT.	-SHEET
BRK.	-BRICK	ELEC.	-ELECTRIC/ELECTRICAL	LT.	-LIGHT	SHWR.	-SHOWER
BRKT.	-BRACKET	ELEV.	-ELEVATION	MAS.	- MASONRY	SL.	-SLIDING
BRD.	-BOARD	EQ.	-EQUAL	MAT'L.	-MATERIAL	SPECS.	-SPECIFICATIONS
BLK.	-BLOCK	EQUIP.	-EQUIPMENT	MAX.	-MAXIMUM	SW.	-SWITCH
BOT.	-BOTTOM	ES.	-EACH SIDE	MECH.	-MECHANICAL	T.J.I.	-TRUSS JOIST INCORPORATED
CAB.	-CABINET	EXIST.	-EXISTING	MIN.	-MINIMUM	TOS	-TOP OF SLAB
C.J.	-CONTROL JOINT, CEILING JOISTS	EXT.	-EXTERIOR	MISC.	-MISCELLANEOUS	T&G	-TONGUE AND GROOVE
CLG.	-CEILING	EXH.	-EXHAUST	M.O.	-MASONRY OPENING	TEMP.	-TEMPERED
CMU	-CONCRETE MASONRY UNIT	FD	-FLOOR DRAIN	MTL.	-METAL	T.B.R.	-TO BE REMOVED
CSMU	-CALCIUM SILICATE MASONRY	F.J.	-FLOOR JOISTS	N/A	-NOT APPLICABLE	TV	-TELEVISION
UNIT	-OAEGIGINI GIEIGATE MAGGINITI	FLR.	-FLOOR	N.I.C.	-NOT IN CONTRACT	TYP.	-TYPICAL
C.O.	-CASED OPENING	FND.	-FOUNDATION	N.T.S.	-NOT TO SCALE	T.O.C.	-TOP OF CONCRETE
CONC.	-CONCRETE	F.P.	-FIREPLACE	0/	-OVER	T.O.P.	-TOP OF PLATE
CONT.	-CONTINUOUS	FPHB	-FREEZE-PROOF HOSE BIBB	0.C.	-ON CENTER	U.C.	-UNDER CABINET
CONT.	- CONSTRUCTION	FTG.	-FOOTING	OPT.	-OPTIONAL	UCR	-UNDER COUNTER REFRIGERATOR
C.S.	-CORNER SET	FURN.	-FURNACE	0.H.	-OVERHEAD, OVERHANG	U.L.	-UNDERWRITER'S LABORATORY
CORR.	-CORRIDOR	F.V.	-FIELD VERIFY	PFA	-POST FROM ABOVE	U.N.O.	-UNLESS NOTED OTHERWISE
CPT.	-CARPET	GA.	-GAGE	117	-PLATE	0.N.O. W	-WASHER
CT CT	-CERAMIC TILE	GA. GEN.	-GENERAL	ı∟ PKT.	-POCKET	W/	-WITH
D	-DRYER	GEN. GFI	-GROUND FAULT INTERRUPTOR	PR.	-PAIR	W.I.C.	-WALK-IN CLOSET
D.B.	-DRAWER BASE	GL.	-GLASS	PRE-FAB	-PREFABRICATED	WD.	-WOOD
D.B. DBL.	-DOUBLE	GL. G&N	-GLUE AND NAIL	P&S	-POLE AND SHELF	WDW	-WINDOW
DBL.	-DESIGNED BY OTHERS	GR	-GRADE	P.S.L.	-PARALLEL STRAND LUMBER	W/O	-WITHOUT
DEFS.	-DIRECT EXTERIOR FINISHING	GR GRAN.	-GRANULAR FILL	P.T.	-PRESSURE TREATED	VV/O V.	-WITHOUT -VANITY
SYSTEM	-DINECT EXTENSION TINISHING	H.C.	-HANDICAP ACCESSIBLE	R.R.	-ROOF RAFTER	v. V.B.	-VAPOR BARRIER
DIFS.	-DECORATIVE INTERIOR FINISHING		-HEADER	R.H.	-RAISED HEEL	v.b. WP	-WATERPROOF
SYST.	-DECORATIVE INTERIOR FINISHING	HR.		RA	-RETURN AIR		
DIM.	-DIMENSION	пк. HRDWD.	-HOUR, HANDRAIL -HARDWOOD	REF.	-REFRIGERATOR	WWF	-WELDED WIRE FABRIC
	-DISPOSAL			REQ'D.	-REQUIRED		
DISP.		HT.	-HEIGHT		-ROOF VENT		
DN.	-DOWN	HWH	-HOT WATER HEATER	RV	-NOUF VEIVI		

Mr. and Mrs. Clark 9029 Clayton Road Ladue, MO 63117



THOMAS ALAN GROUP

ARCHITECTURE | DESIGN | INTERIORS

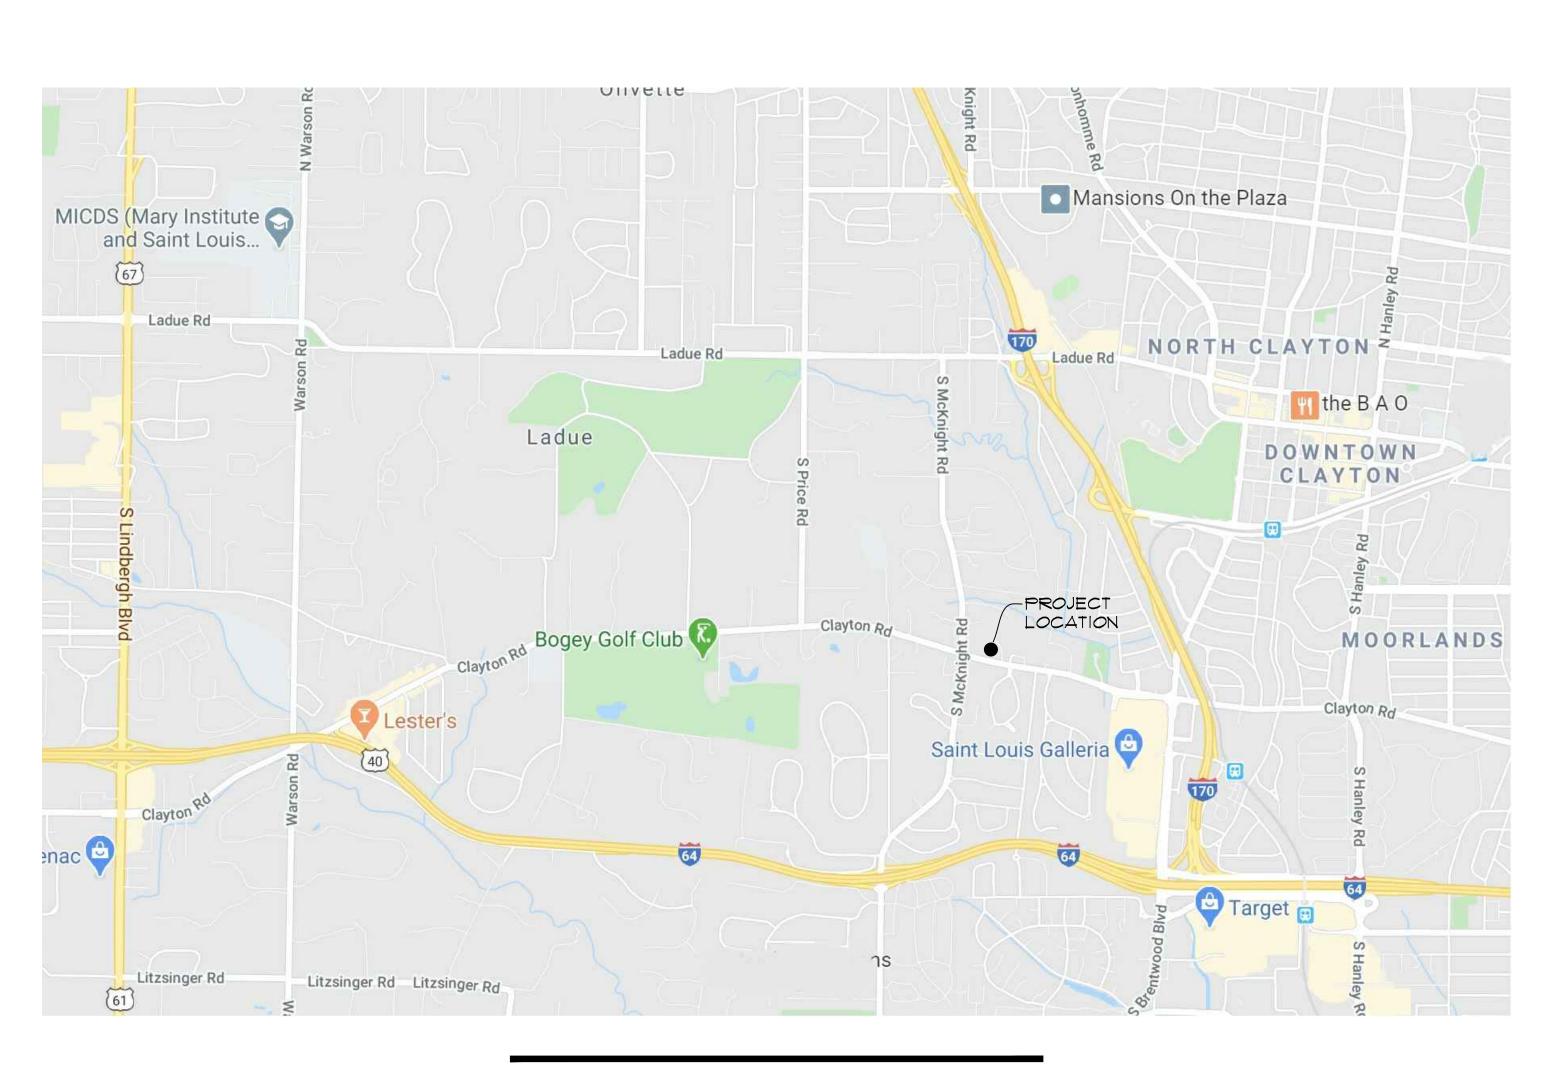

PROJECT VICINITY MAP


NO SCALE

THOMAS ALAN GROUP

COPYRIGHT © 2020 THOMAS ALAN GROUP

THOMAS

Sheet Number: COVER PAGE of 18

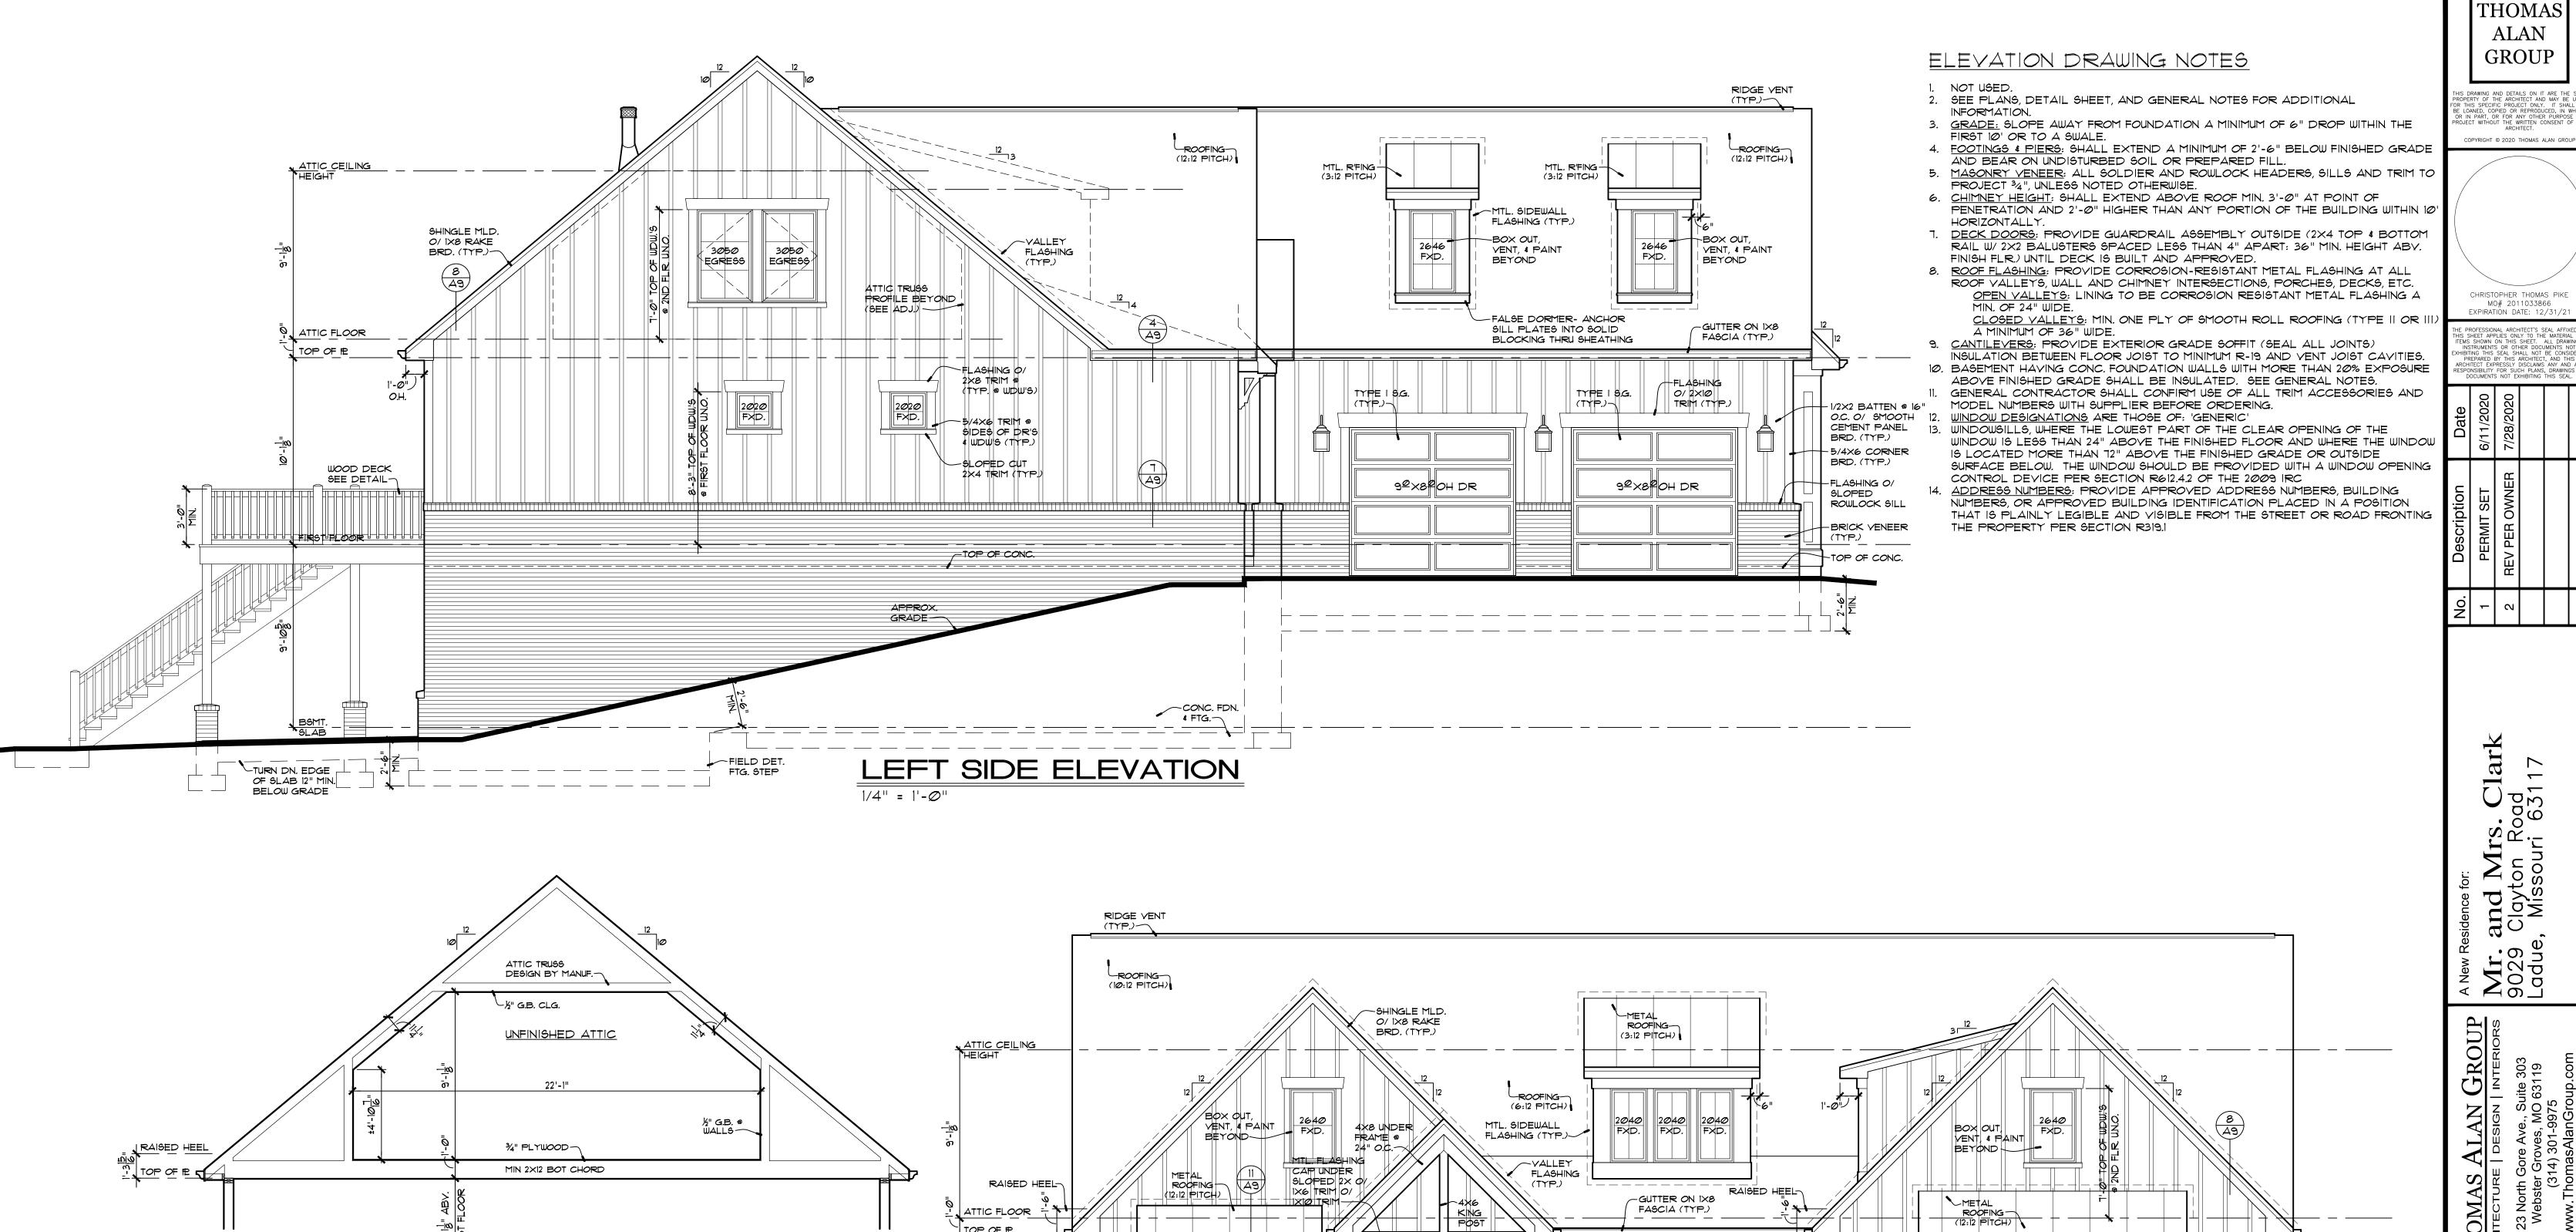

2650 2650 2650 EGRESS FIXED EGRESS

FYPON BRK. SEE DTL

TOP OF PE

ATTIC TRUSS PROFILE

1/2×2 BATTEN @ 16"

O.C. O/ SMOOTH
CEMENT PANEL
BRD. (TYP.)

5/4X6 CORNER BRD. (TYP.)

FLASHING O/ SLOPED

ROWLOCK SILL-

BRICK VENEER (TYP.)

TOP OF CONC.

-CONC. FDN.

FTG.

FIRST FLOOR

BASEMENT SLAB

and ANE MIT. 9029 THOMAS ALAN GROUP FRON ELEV AND **Sheet Number:**

FRONT ELEVATION

3050

10" SQ. BUILT-UP COLUMN (TYP.)

FLASHING O/ SLOPED ROWLOCK SIL,

5/4X CORNER BRD. & TRIM

SLOPED CUT 5/4×12/

2656 FXD.


2656 FXD.


2656 FXD.

19

1/4" = 1'-0"

3050

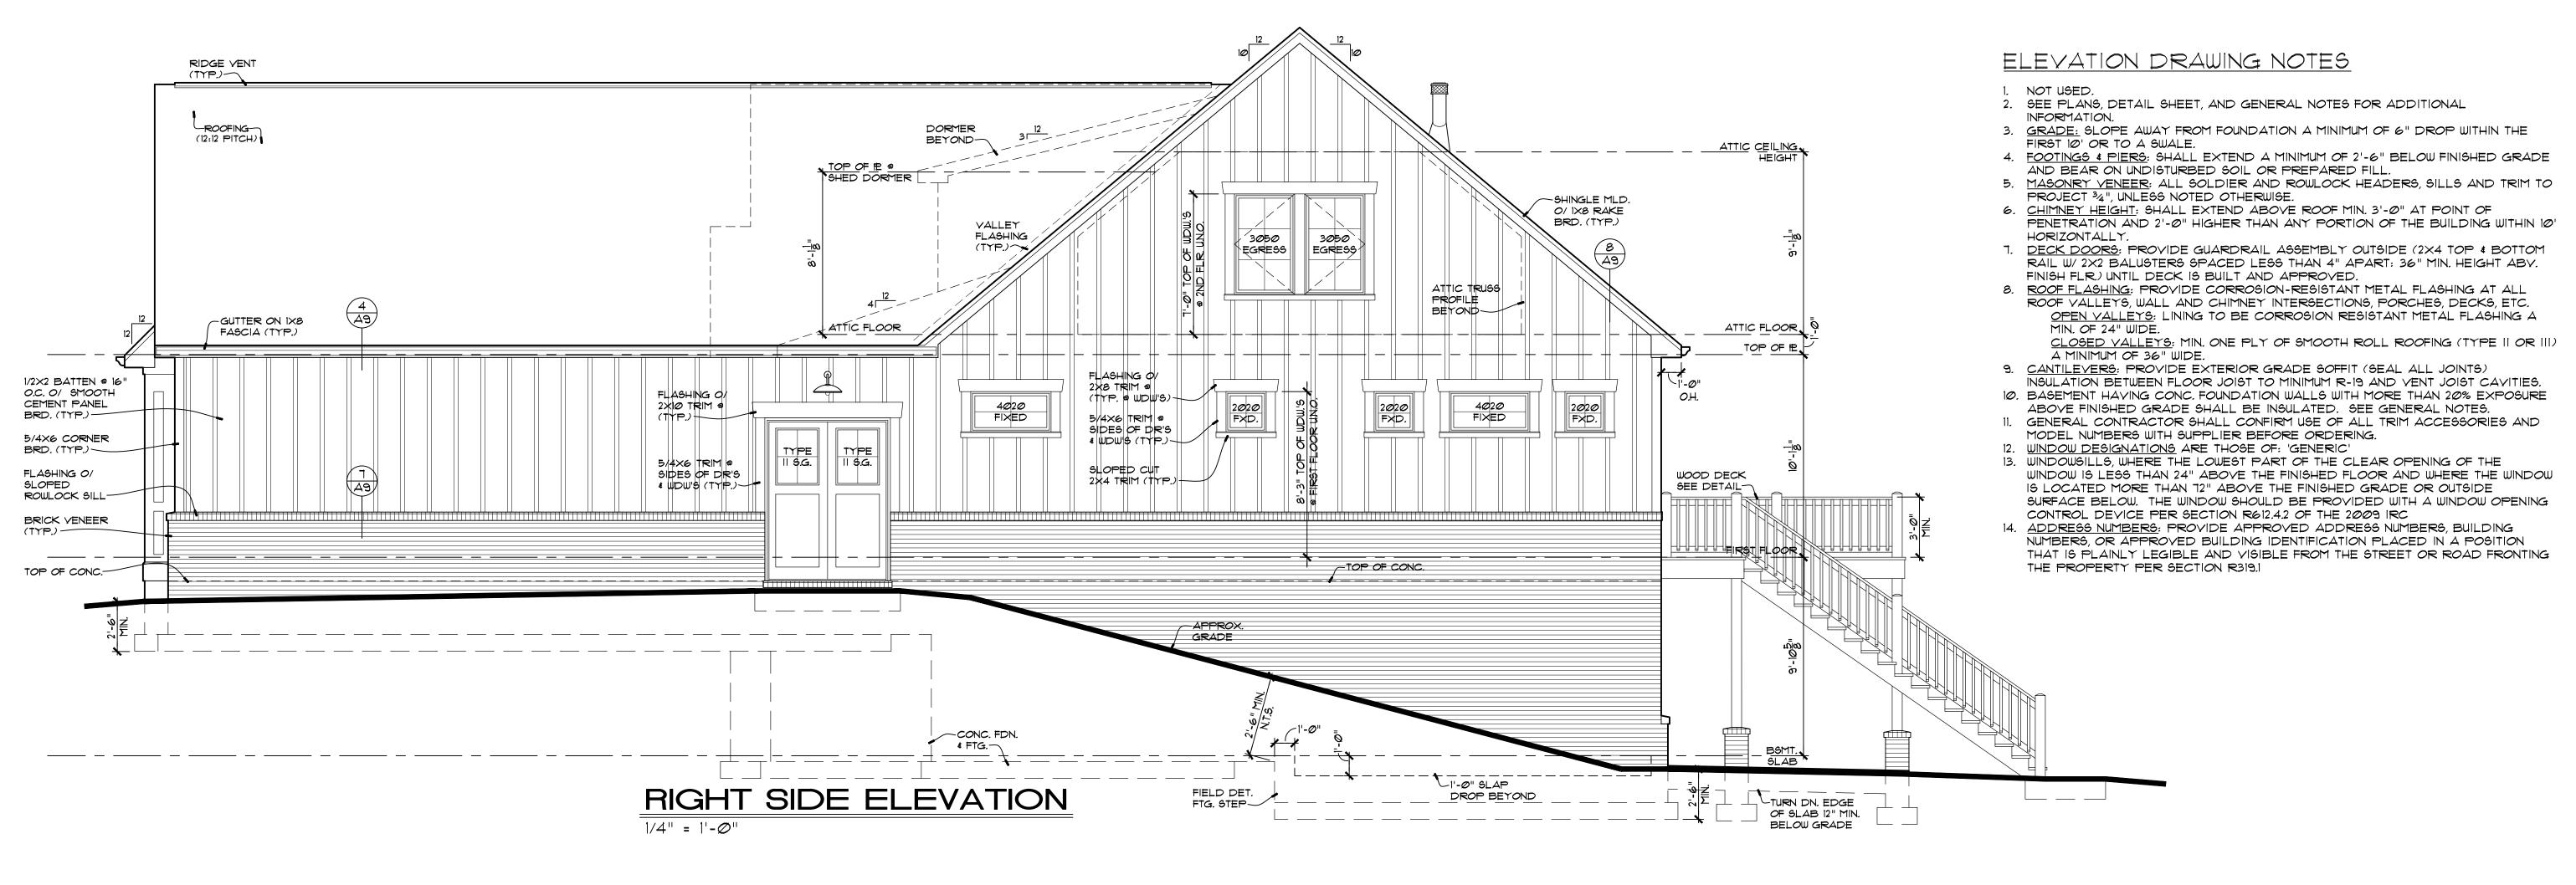

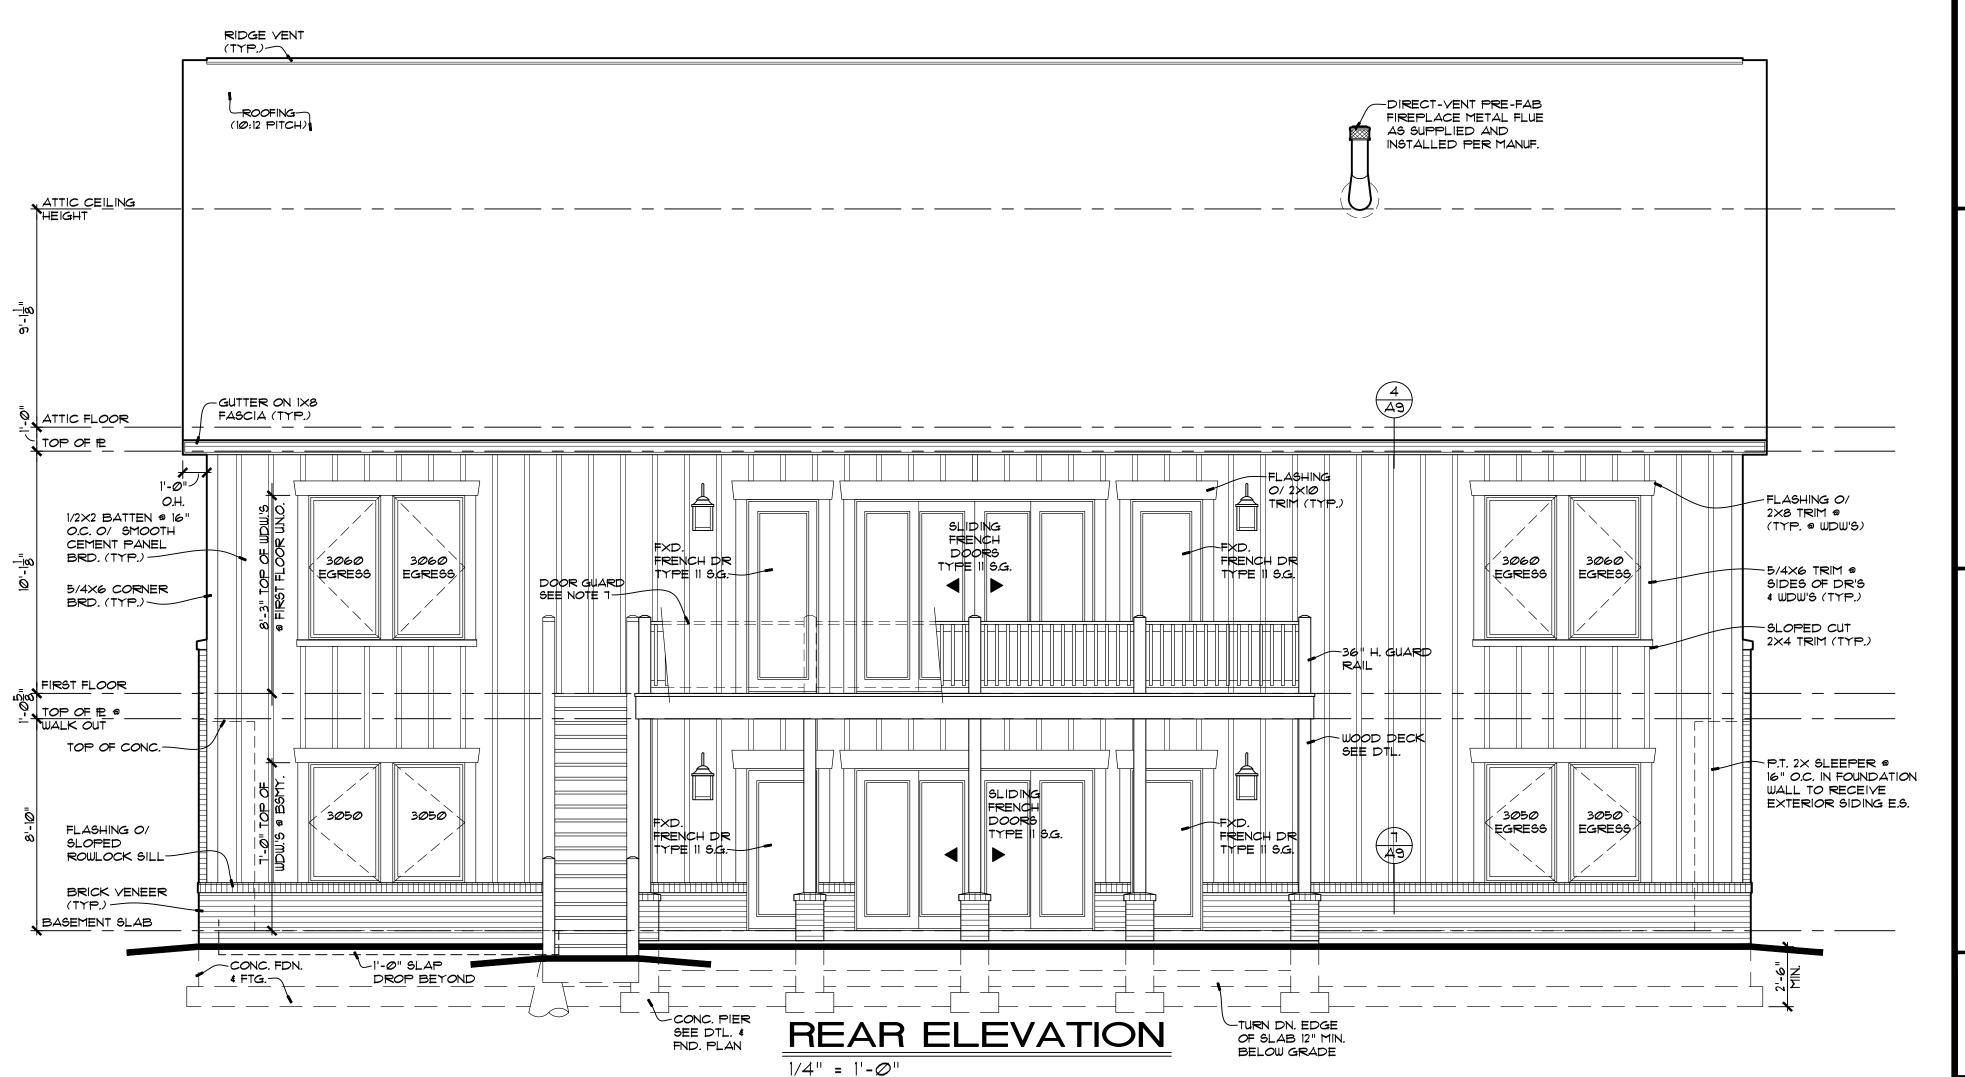



THIS DRAWING AND DETAILS ON IT ARE THE S
PROPERTY OF THE ARCHITECT AND MAY BE U
FOR THIS SPECIFIC PROJECT ONLY. IT SHALL
BE LOANED, COPIED OR REPRODUCED, IN WH
OR IN PART, OR FOR ANY OTHER PURPOSE
PROJECT WITHOUT THE WRITTEN CONSENT OF

COPYRIGHT @ 2020 THOMAS ALAN GROUP

CHRISTOPHER THOMAS PIKE MO# 2011033866

EXPIRATION DATE: 12/31/21

E PROFESSIONAL ARCHITECT'S SEAL AFFIXED TO SS SHEET APPLIES ONLY TO THE MATERIAL AND EMS SHOWN ON THIS SHEET. ALL DRAWINGS, INSTRUMENTS OR OTHER DOCUMENTS NOT HIBITING THIS SEAL SHALL NOT BE CONSIDERED PREPARED BY THIS ARCHITECT, AND THIS CHITECT EXPRESSLY DISCLAIMS ANY AND ALL SPONSIBILITY FOR SUCH PLANS, DRAWINGS OR DOCUMENTS NOT EXHIBITING THIS SEAL.

PERMIT SET 6/11/2020

REV PER OWNER 7/28/2020

A New Residence for:


Mr. and Mrs. Clark
9029 Clayton Road
Ladue, Missouri 63117

THOMAS ALAN GROUP
ARCHITECTURE | DESIGN | INTERIORS
23 North Gore Ave., Suite 303
Webster Groves, MO 63119


REAR
ELEVATION AND
RIGHT SIDE
ELEVATION

Sheet Number:

A8
of 18

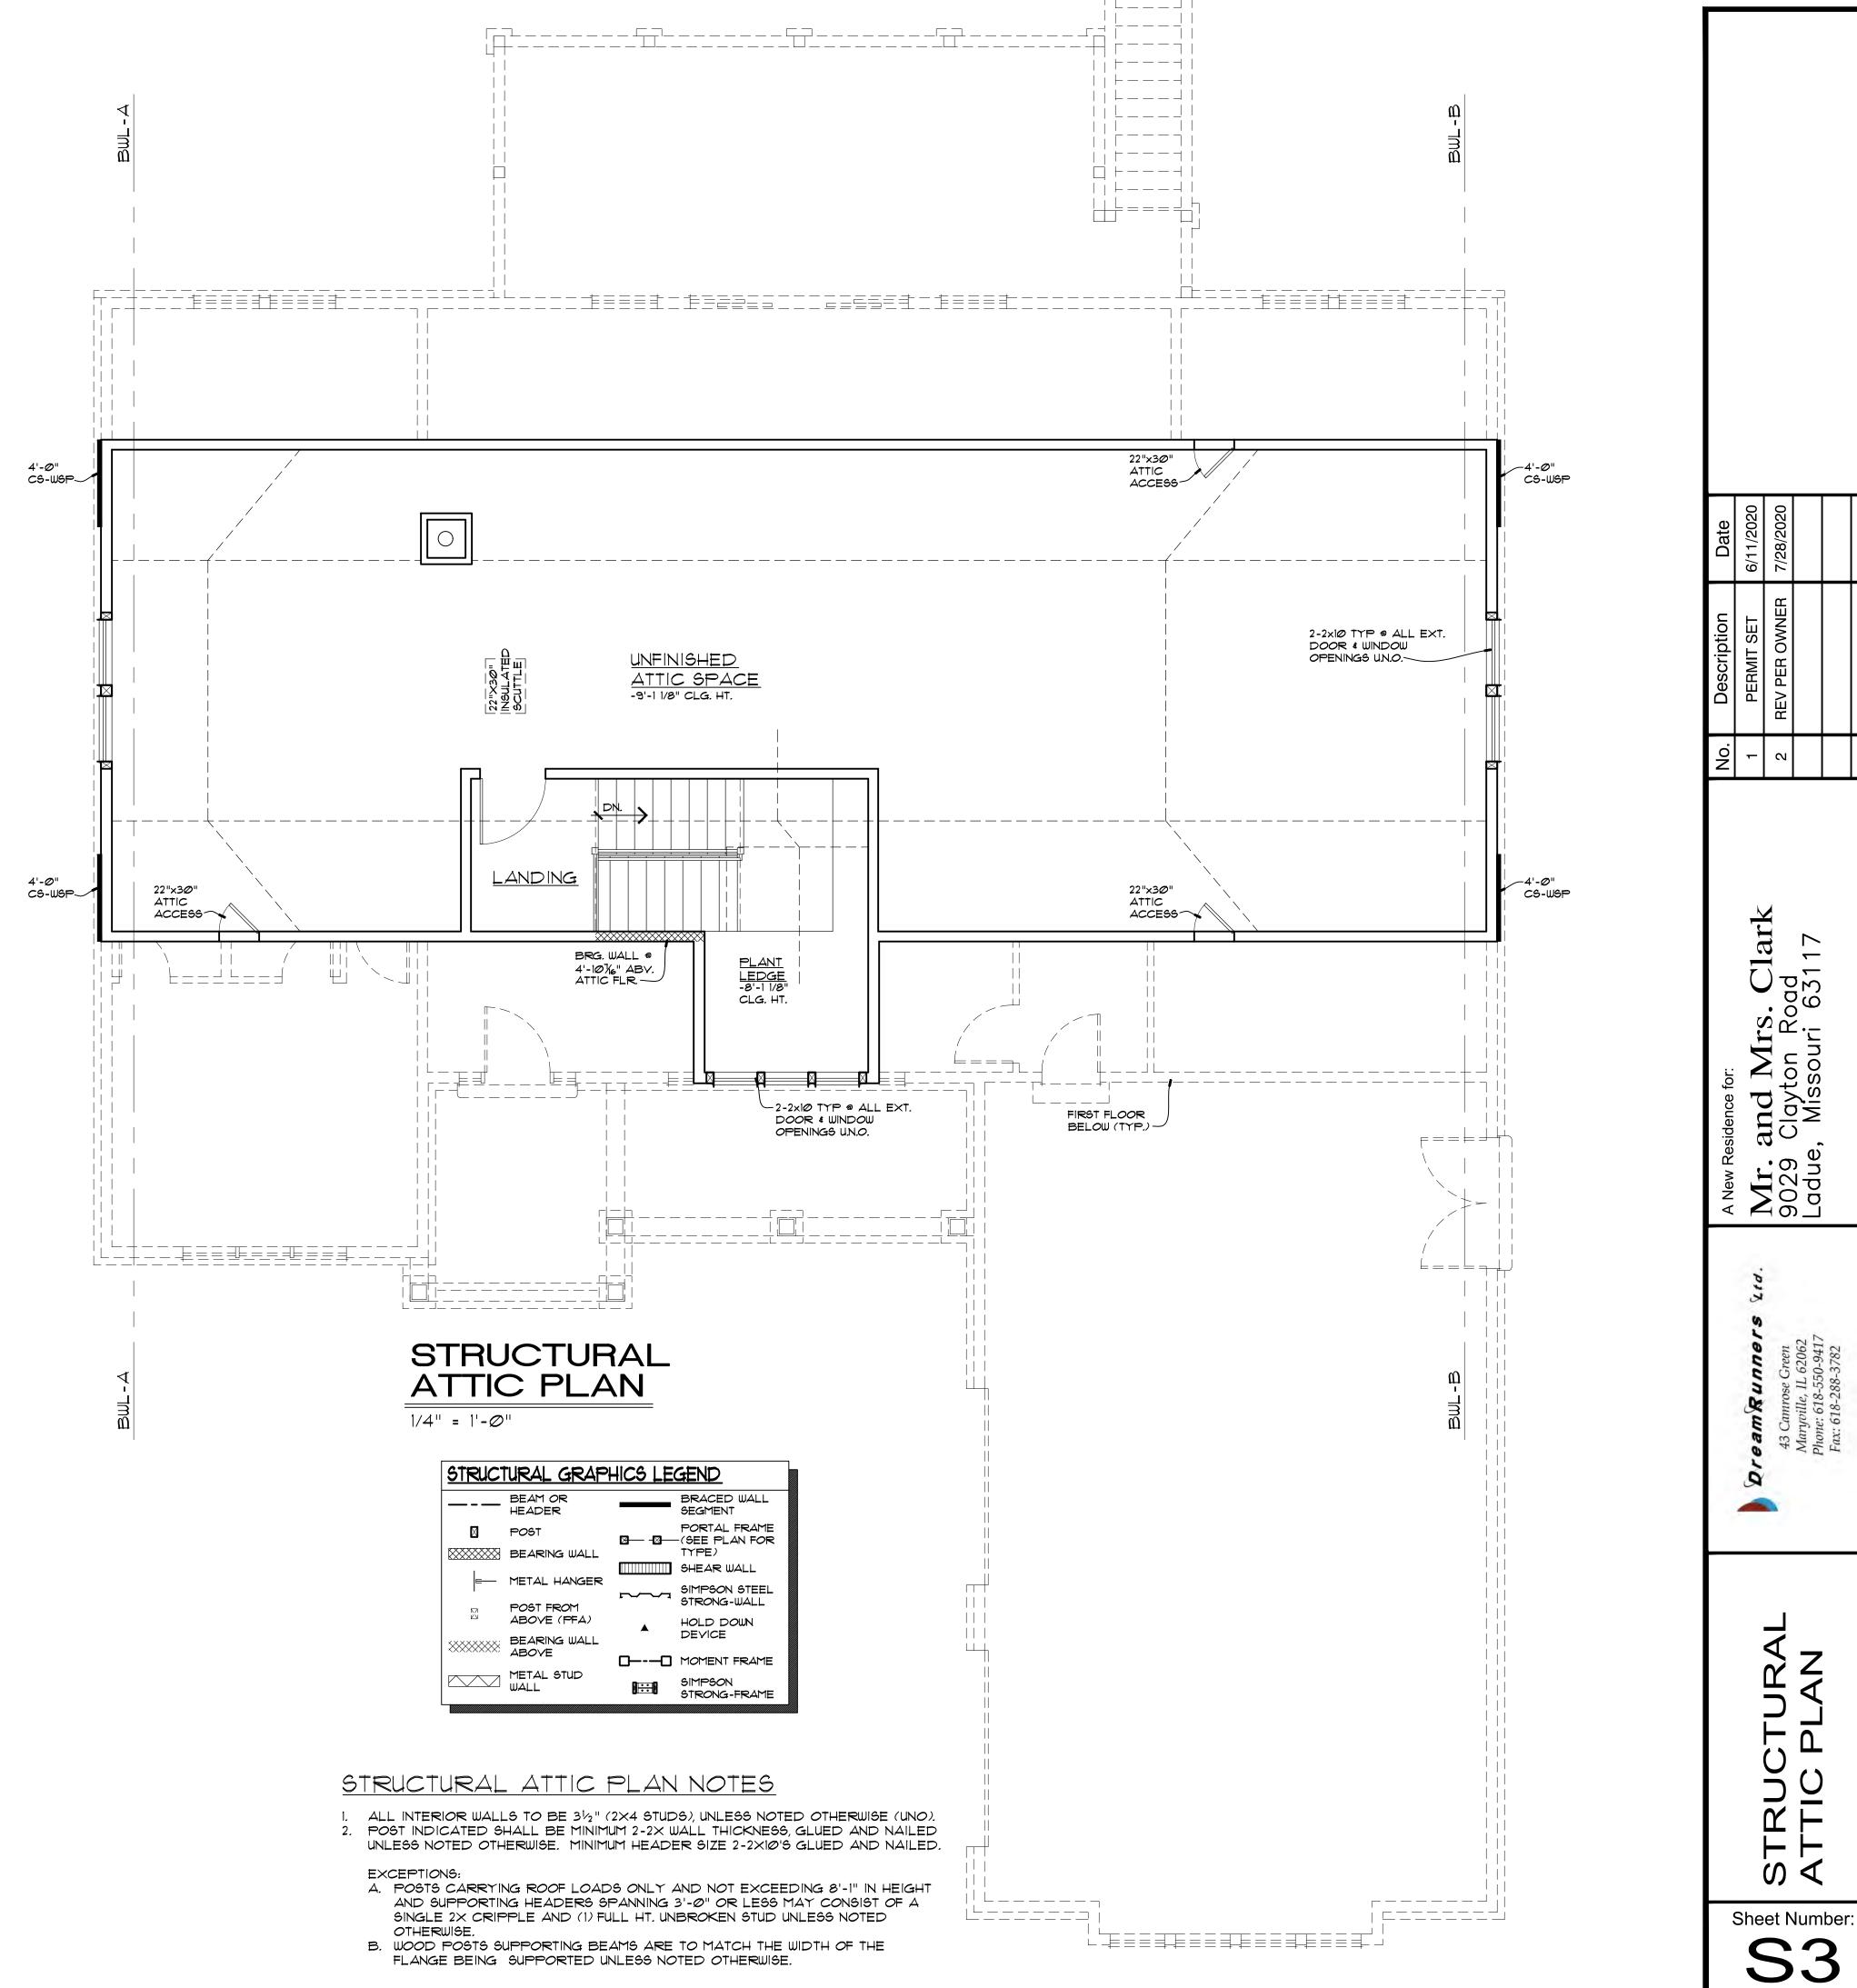

Date	6/11/2020	7/28/2020			
No. Description	PERMIT SET	2 REV PER OWNER			
ON O	1	2			
A New Residence for:	Mr. and Mrs. Clark 9029 Clayton Road Ladue, Missouri 63117				
	Dream Runners Ltd.	43 Camrose Green	Maryville, 1L 62062 Phone: 618-550-9417	Fax: 618-288-3782	
STRUCTURAL ATTIC PLAN					

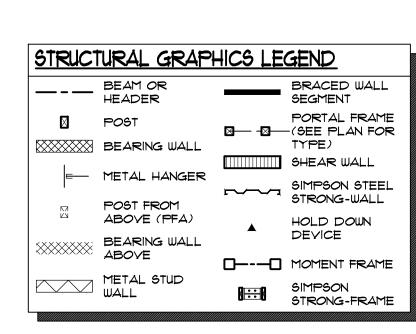


NOTE:
WHERE PROPOSED FOOTINGS OR CONCRETE
PAD'S ARE BEARING ON FILL, ENGINEERED
FILL SHALL BE DESIGNED TO MIN. 2000*FT.
BEARING CAPACITY AND BE CERTIFIED IN
WRITING BY REGISTERED AND LICENSED
GEOTECHNICAL ENGINEERING PROFESSIONAL
TO OWNER AND ARCHITECT. OR
CONTRACTOR CAN EXTEND FOOTING DEPTH
TO BEAR ON MINIMUM 12" INTO VIRGIN SOIL

STRUCTURAL ROOF FRAMING NOTES

- . ALL INTERIOR WALLS TO BE $3\frac{1}{2}$ " (2×4 STUDS), UNLESS NOTED OTHERWISE (UNO). POST INDICATED SHALL BE MINIMUM 2-2× WALL THICKNESS, GLUED AND NAILED UNLESS NOTED OTHERWISE. MINIMUM HEADER SIZE 2-2×10/9 GLUED AND NAILED.
- EXCEPTIONS:

 A. POSTS CARRYING ROOF LOADS ONLY AND NOT EXCEEDING 8'-1" IN HEIGHT AND SUPPORTING HEADERS SPANNING 3'-0" OR LESS MAY CONSIST OF A SINGLE 2X CRIPPLE AND (1) FULL HT. UNBROKEN STUD UNLESS NOTED OTHERWISE.
- B. WOOD POSTS SUPPORTING BEAMS ARE TO MATCH THE WIDTH OF THE FLANGE BEING. SUPPORTED UNLESS NOTED OTHERWISE.
- 3. SEE ARCHITECTURAL FIRST AND SECOND FLOOR PLANS FOR INTERIOR CEILING CONDITIONS.
- 4. TRUSS LAYOUT SHOWN IS FOR DIAGRAMMATIC PURPOSES ONLY. SEE MANUFACTURERS SHOP DRAWINGS FOR ACTUAL LAYOUT, INFORM ARCHITECT IMMEDIATELY FOR ANY DISCREPANCIES

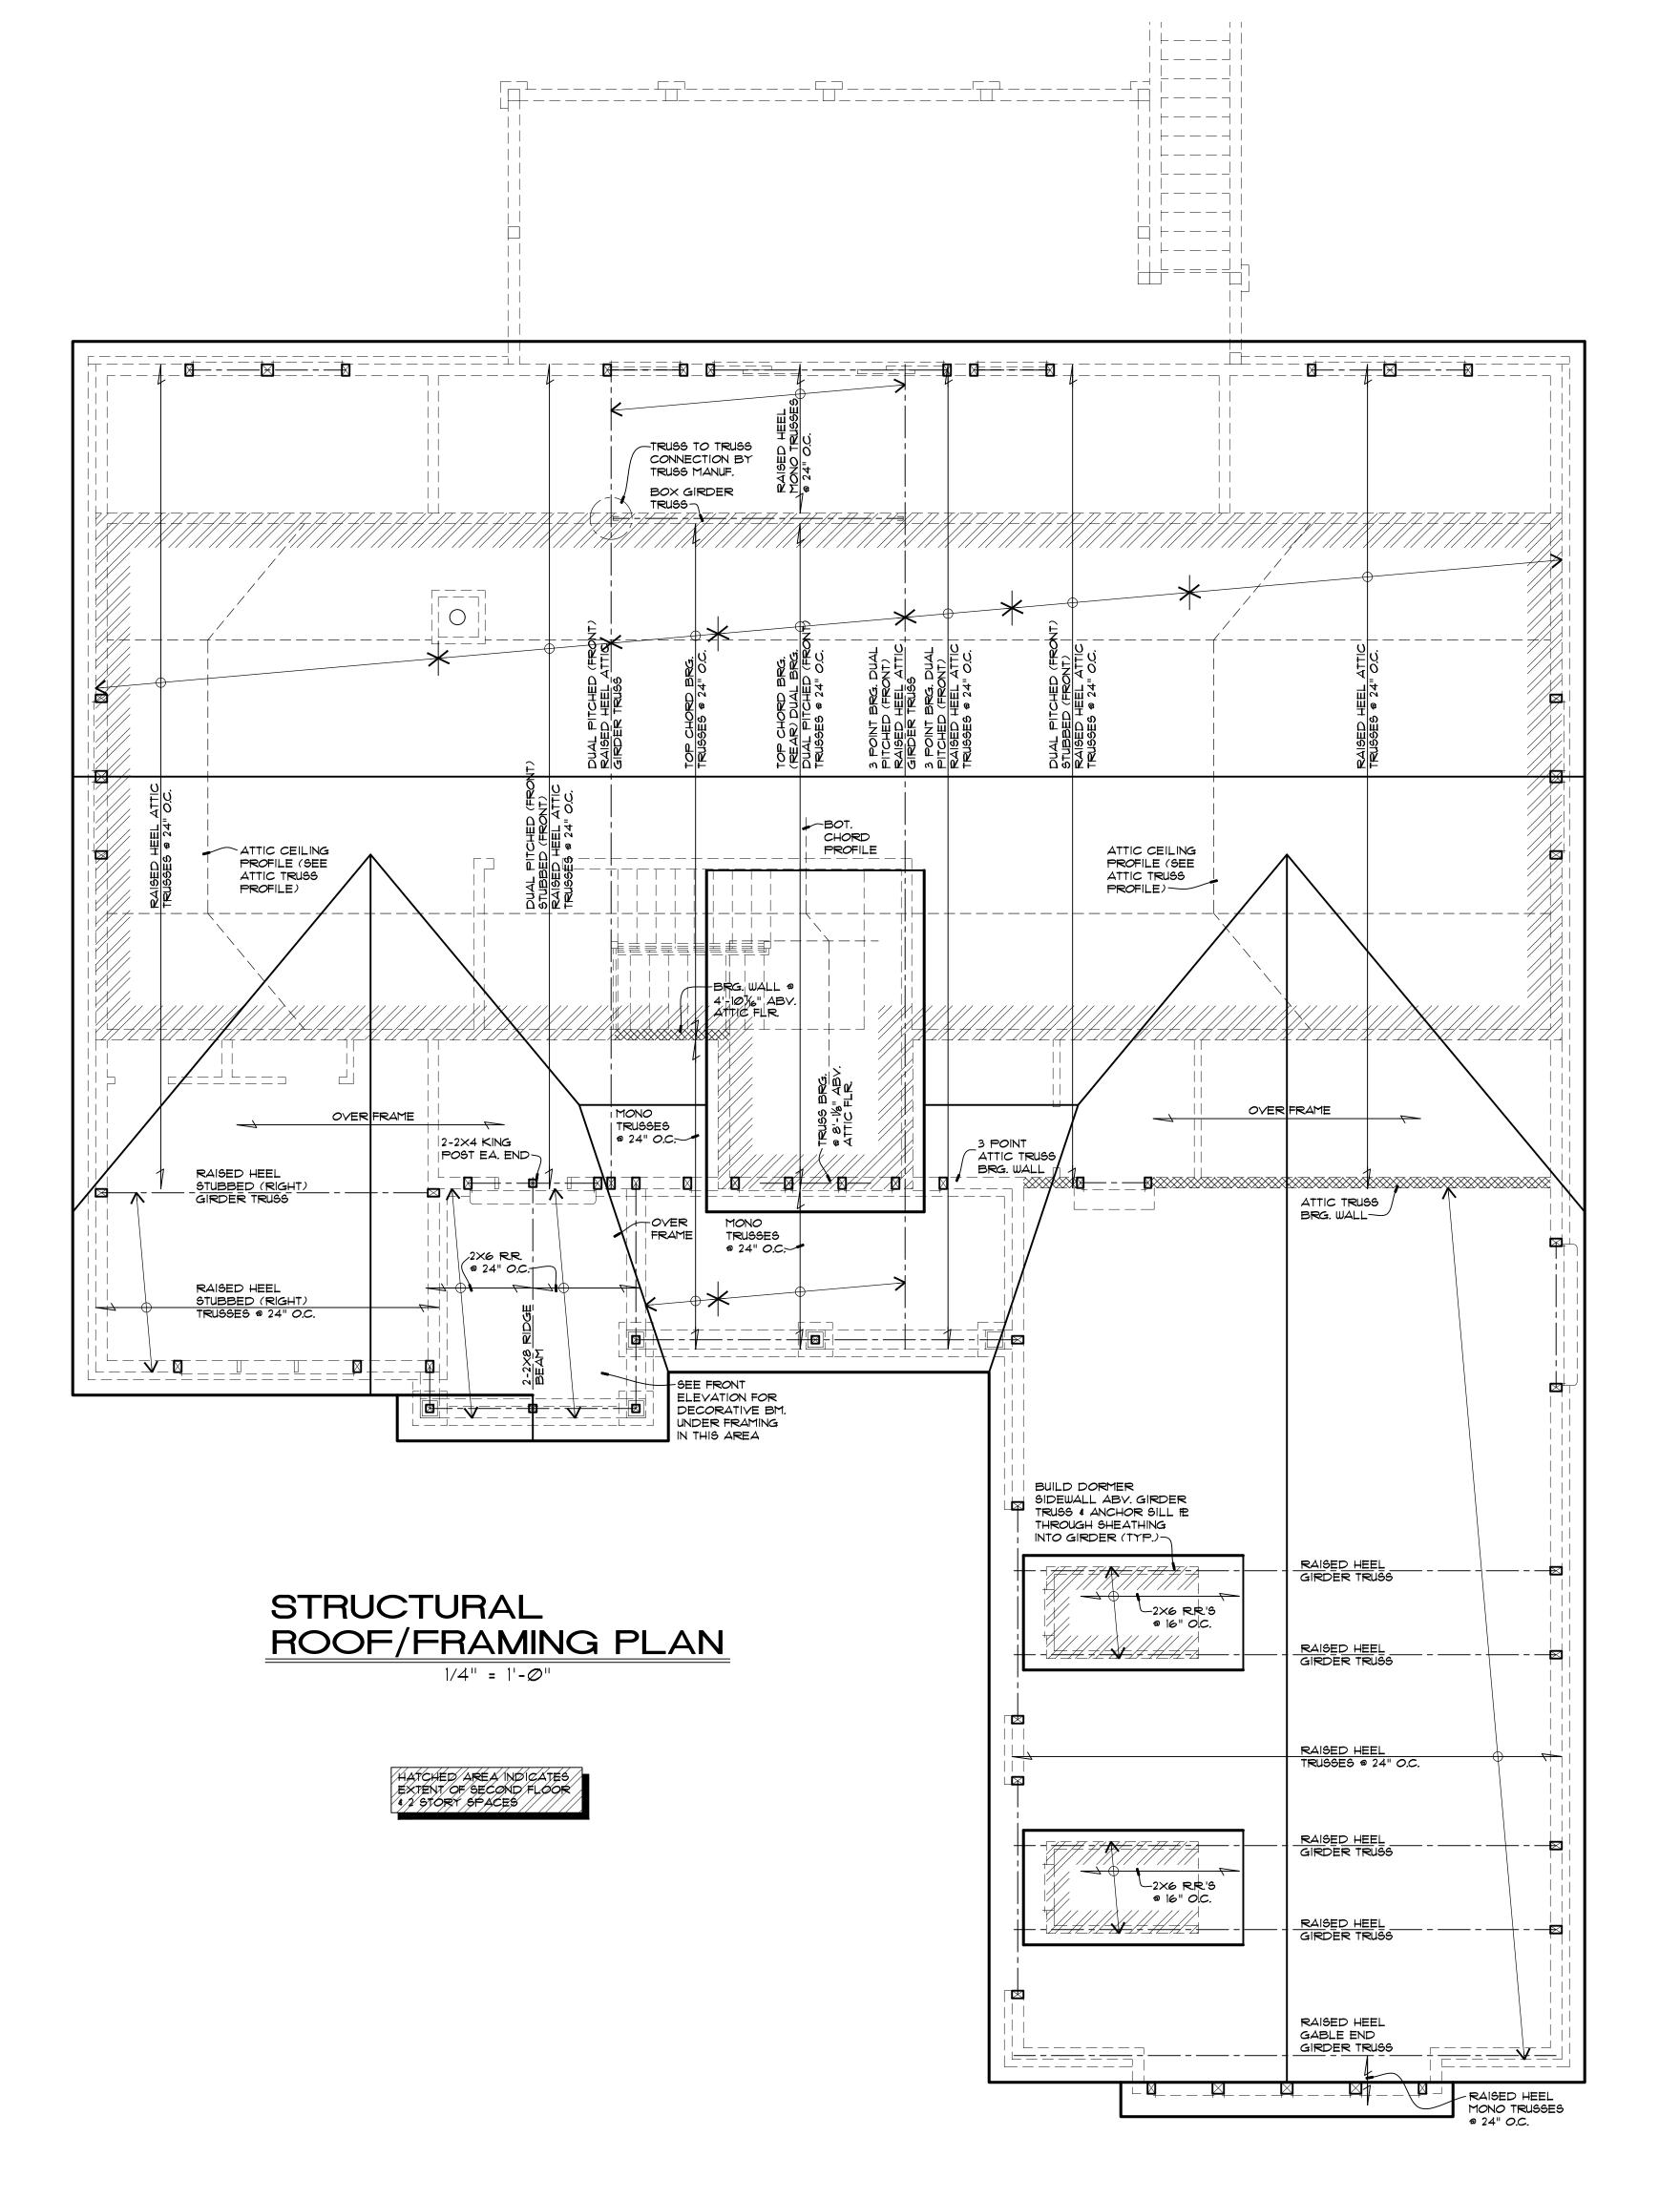

Mr 9029 Ladu

Sheet Number:



















ANDERSON CLAD WINDOWS



GAF TIMBERLINE TAMKO 30 YR ARCHITECTURAL



JAMES HARDY FIBER CEMENT ARTIC WHITE



THERMA TRU DOUBLE S82103 3'0"x8'0"



KWIK SET SAN CLEMENTE



HBG SQUARE PERMACAST COLUMNS



HAAS 360 GARAGE DOOR



AZTEC WHITE CLOSURE



	WHALEN CUSTOM HOMES					
	BUILDING ENCLOSURE MATERIALS					
PURCHASER	JILL AND BRENT CLARK					
TITLE COMPANY	INTEGRITY					
LOCATION	LADUE					
ADDRESS	9029 CLAYTON RD, ST. LOUIS, MO 63117					
PLAN	CUSTOM					
PERMIT#						
EXTERIOR						
SHINGLES	GAF TIMBERLINE TAMKO 30 YR ARCHITECTURAL					
SIDING/SOFFIT/FACIA	JAMES HARDY FIBER CEMENT ARTIC WHITE / BOARD & BATTEN / VENTED ALUMINUM / ALUMINUM WRAPPED					
EXTERIOR TRIM	WHITE					
GUTTERS	ALUMINUM 5" WITH 2" X 3" DOWNSPOUTS W/ GUTTER GUARDS					
BRICK	AZTEC WHITE CLOSURE					
STONE	NONE					
WINDOWS	ANDERSEN CLAD WINDOWS					
FRONT DOOR	THERMA TRU DOUBLE S82103 3'0"x8'0" PAINTED BLACK					
EXT. HARDWARE	KWIK SET SAN CLEMENTE IN MATTE BLACK					
PORCH COLUMNS	HBG SQUARE PERMACAST COLUMNS					
SHUTTERS	NONE					
GARAGE DOORS	HAAS 360					
GARAGE DOOR COLOR	BLACK					
NOTES						